



- Select a good visible spot in your community or park where you want to install the Pet Waste Station
- 2. Prior to installation, remove the 1¾" x 1¾" x 4' portion of the mounting post from the 2" x 2" x 4' portion of the mounting post before cementing. Insert the larger portion of the mounting post (2" x 2" x 4') approximately 14" into an 18" deep by 8" diameter hole filled with a 40 lb. bag of "ready to use" concrete mix. To stabilize the post while cementing, place a rod, bolt or other device through the two bottom holes, prior to inserting into the ground and cementing. Level the post in a straight vertical position and let concrete dry for at least 12 hours.
- 3. After the concrete is dry, insert the smaller portion of the post (1¾" x 1¾" x 4') into the larger cemented portion of the post (2' x 2' x 4') until the first 4 holes are lined up between the two posts. Use two (2) carriage bolts, washers and locknuts to fix the telescopic post in position. The upper bolt in the top overlapping hole, pointing from right to left and the lower bolt in the bottom overlapping hole, pointing from front to back. The total hight above ground with both parts should now be approx. 6" 6'.
- 4. Start by installing the Pet Waste Station on top of the 1¾" post, with the upper hole matching the most upper hole in the square post using the enclosed 2½" bolts, washers and locknuts. Continue installing the Pet Waste Bag Dispenser according to

the mounting instructions enclosed with the Dispenser, ensuring that the upper edge of the Dispenser is approximately **1" below** the lower edge of the Pet Waste Sign.


- 5. Install the Steel Trash receptacle through the pre-drilled top oval holes in the back wall of the receptacle and though the square post with the remaining bolts, washers and locknuts, using the 2-3/4 bolt on top and the 2-1/2 bolt below. The upper edge of the trash receptacle must be approx. 12 -1/2 below the lower end of you Aluminum Bag dispenser so that the lid may completely open. The Upper back wall of the trash receptacle is supposed to touch the head of the lower post carriage bolt, which creates some space between the post and the receptacle, allowing the receptacle lid to open from left to right, without touching the post.
- 6. Insert one of the enclosed Pet Waste Bags into the trash receptacle, folding it over th einterior retainer bands. As with any powder coated steel product constantly exposed to the elements, proper installation and general maintenance will help prevent and minimize corrosion and expand the life of the steel trash receptacle.
- 7. ENJOY WATCHING PET OWNERS PICK UP AFTER THEIR DOGS!

*Subject to change without notice

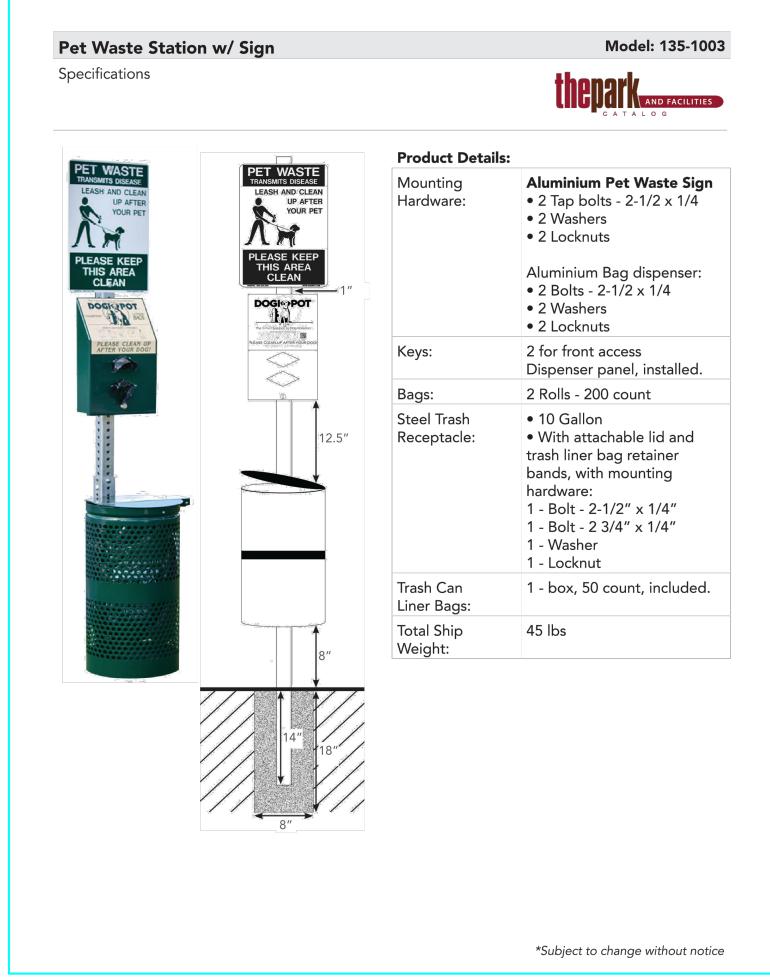

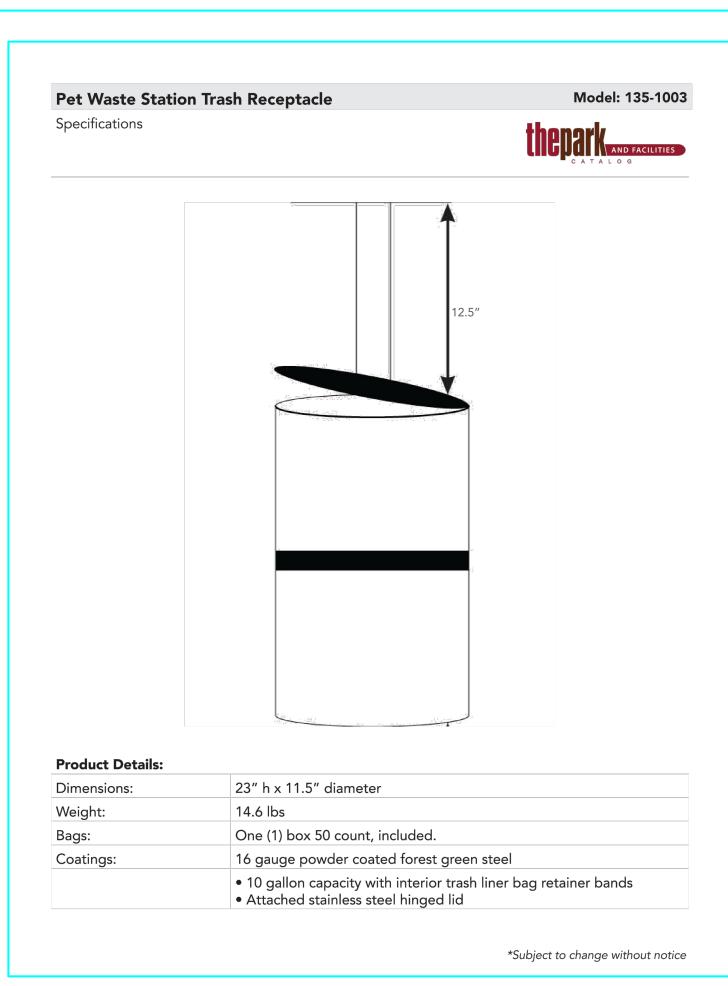



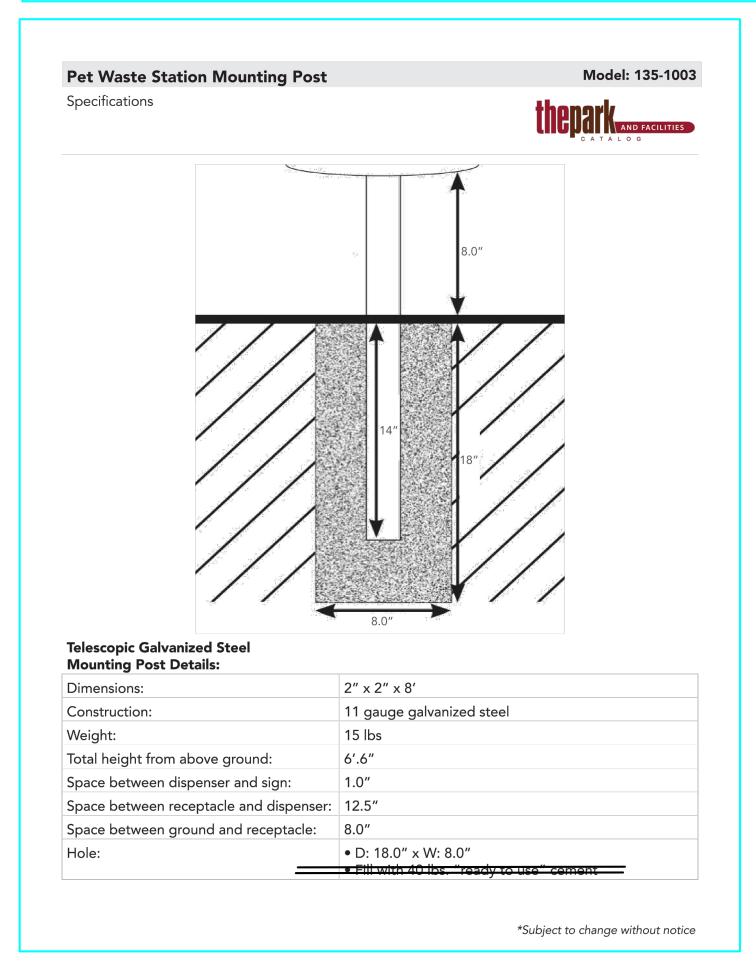

NOTE: THESE MANUFACTURER DETAILS ARE FOR INFORMATIONAL PURPOSES ONLY!! CONTRACTOR TO CONTACT THE SUPPLIER DIRECTLY FOR CONSTRUCTION AND INSTALLATION PURPOSES.

Lake Rowena
Park

Ebensburg, PA
Cambria County, PA
COMPANY ADDRESS:

LANDSCAPE DESIGNER

PROJECT NAME:

BOROUGH OF
EBENSBURG
LAKE ROWENA
DOG PARK

CAMBRIA COUNTY

REV. DATE: DESCRIPTION
ISSUE: 1-27-2022


SCALE: AS-SHOWN
DRAWN BY: Dave Petrosky

PROJECT NO. EBG-01


Revised set: 1-12-23


DETAIL SHEET DOGIPOT PET STATION

S2.03

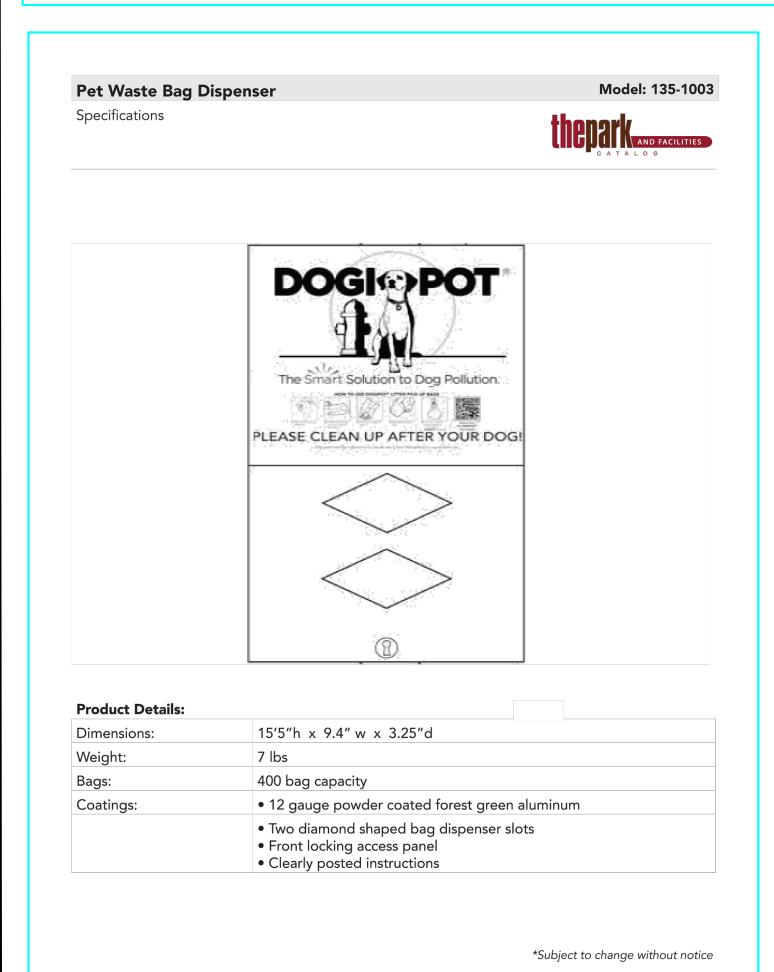


FOR ALL PLAY EQUIPMENT

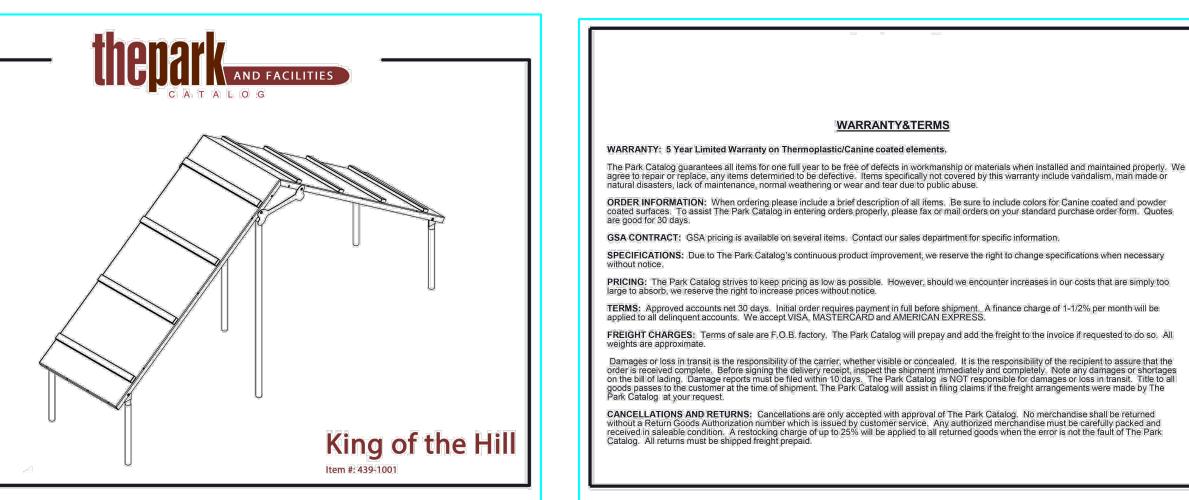

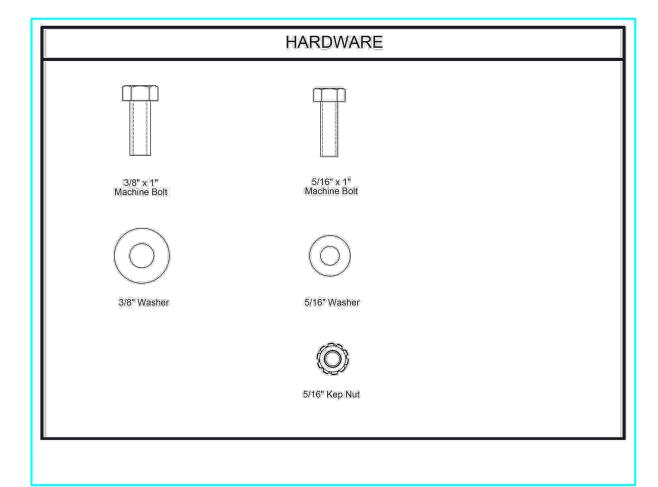

FOR ALL PLAY EQUIPMENT

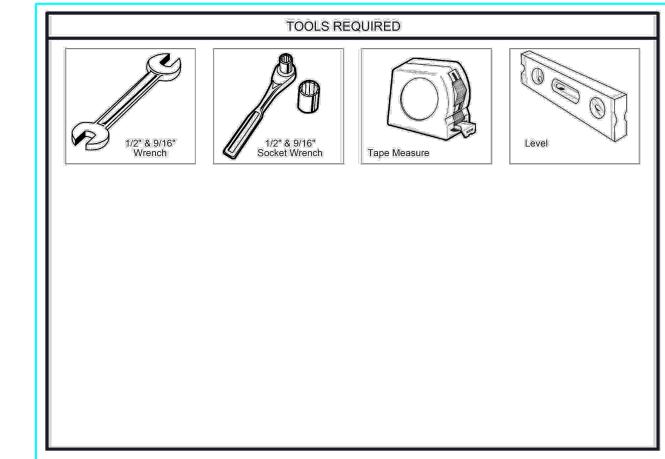


Park Ebensburg, PA Cambria County, PA COMPANY ADDRESS: LANDSCAPE DESIGNER PROJECT NAME:


Lake Rowena


BOROUGH OF **EBENSBURG** LAKE ROWENA **DOG PARK**


CAMBRIA COUNTY




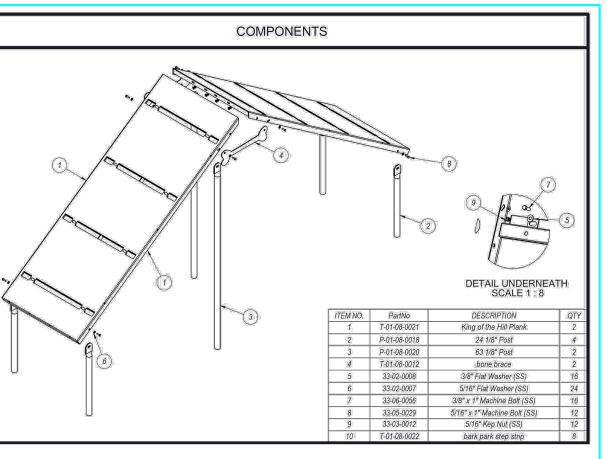


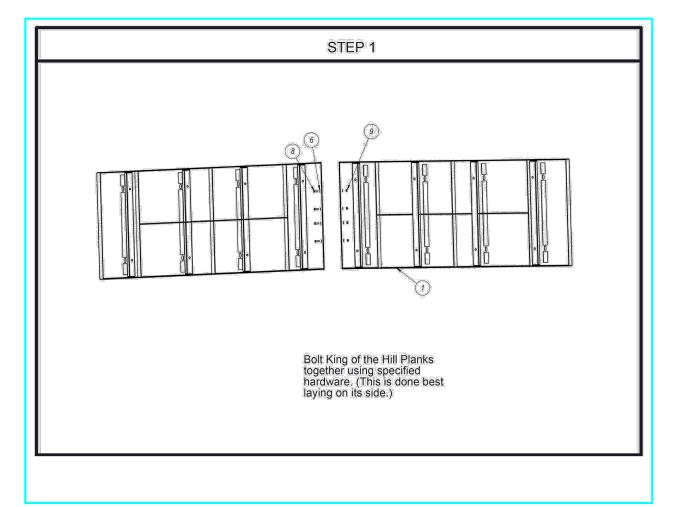


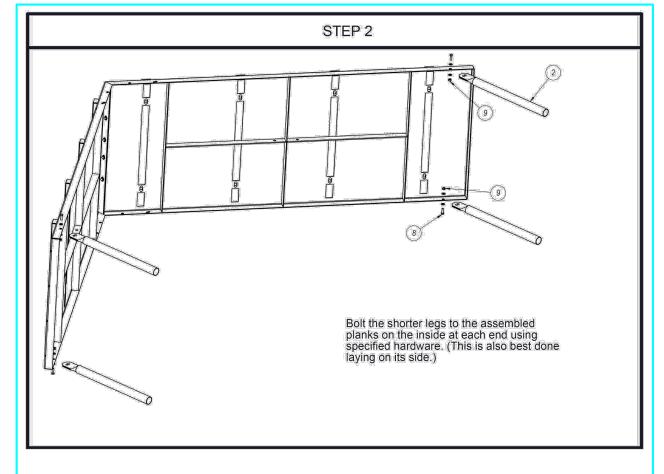

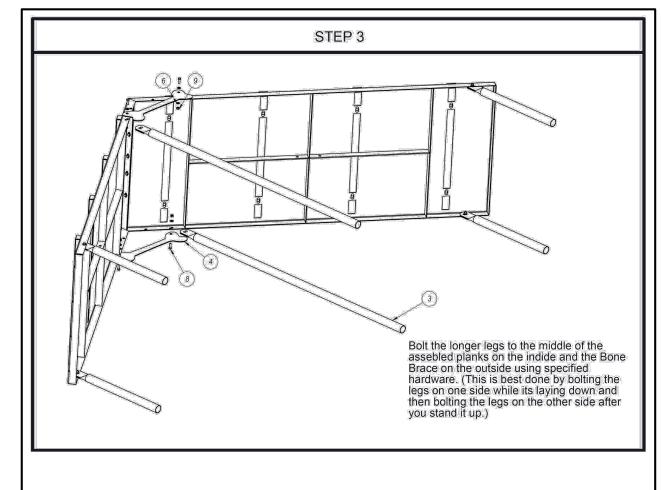

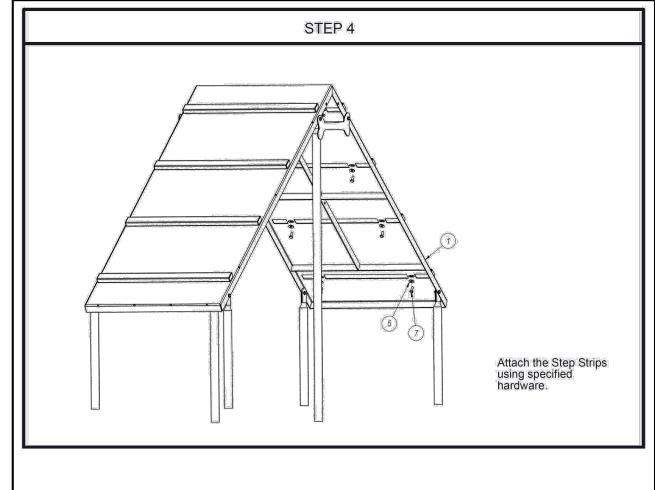

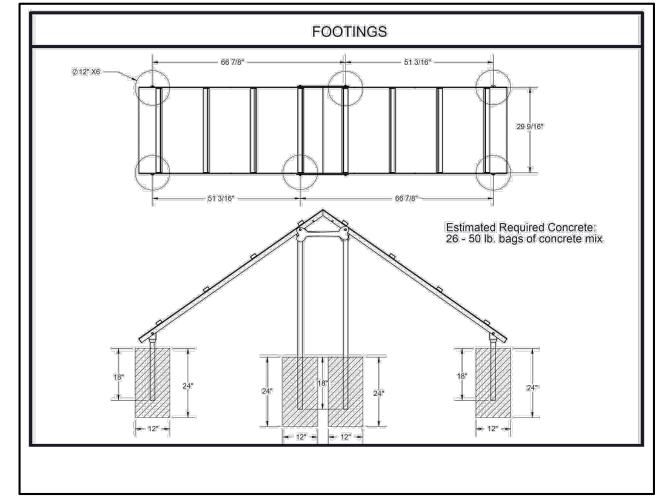

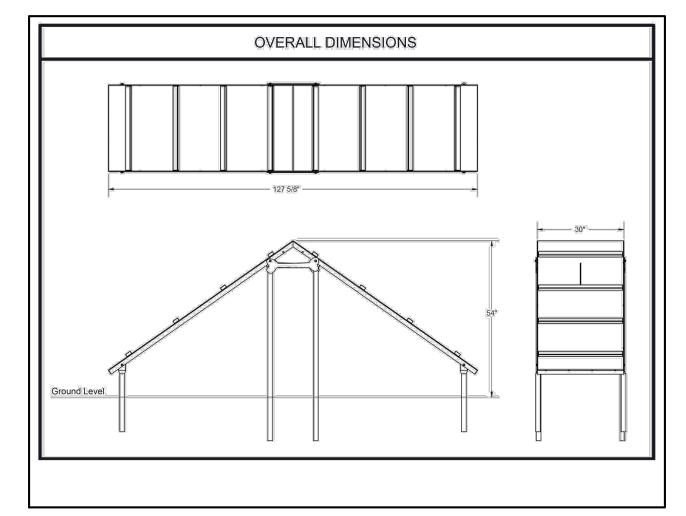



ALL CONCRETE SHALL BE 3000 PSI 28 DAY MINIMUM.


REV. DATE: DESCRIPTION 1-27-2022 PROJECT NO. EBG-01 DRAWN BY: Dave Petrosky Revised set : 1-12-23

DETAIL SHEET KING OF THE HILL SPECS

NOTE: THESE MANUFACTURER DETAILS ARE FOR INFORMATIONAL PURPOSES ONLY!! CONTRACTOR TO CONTACT THE SUPPLIER DIRECTLY FOR CONSTRUCTION AND INSTALLATION PURPOSES.

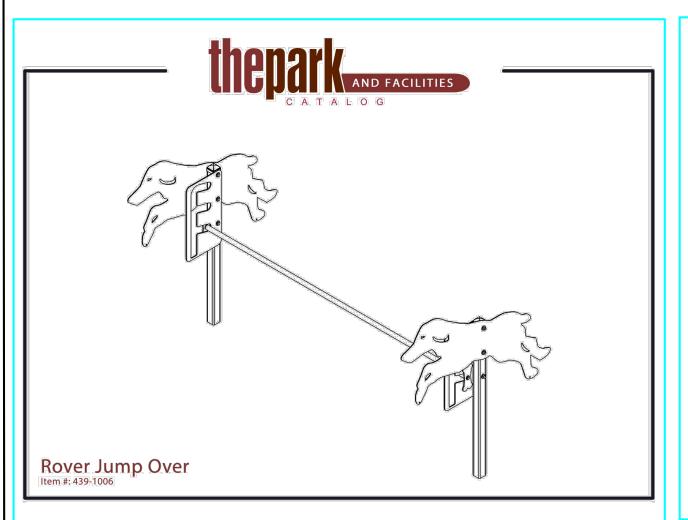

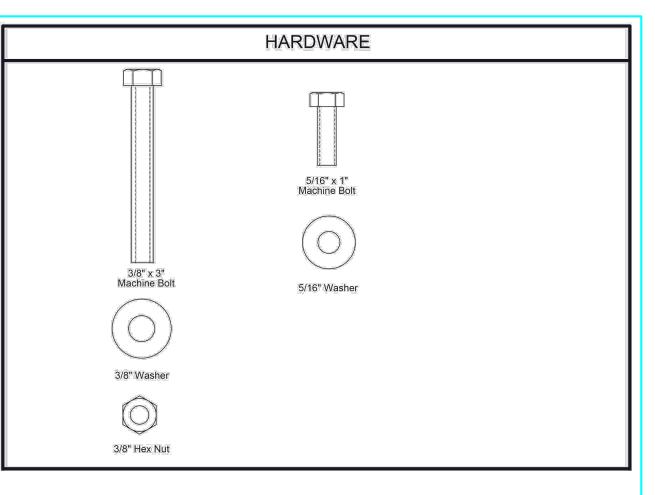

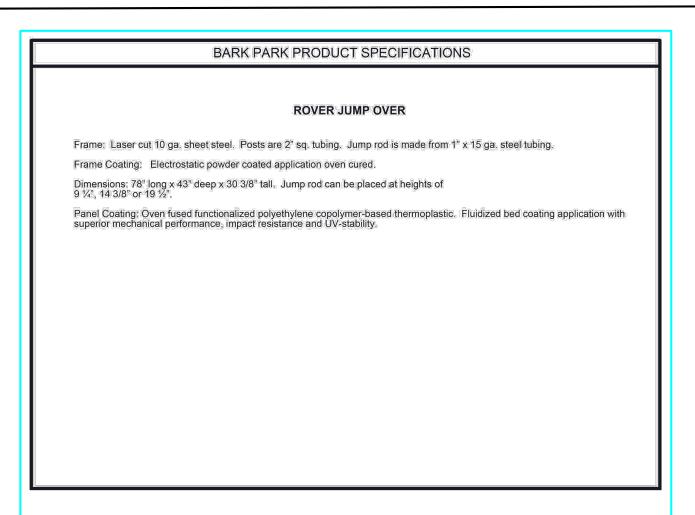

WARRANTY&TERMS

The Park Catalog guarantees all items for one full year to be free of defects in workmanship or materials when installed and maintained properly. We agree to repair or replace, any items determined to be defective. Items specifically not covered by this warranty include vandalism, man made or natural disasters, lack of maintenance, normal weathering or wear and tear due to public abuse.

ORDER INFORMATION: When ordering please include a brief description of all items. Be sure to include colors for Canine coated and powder coated surfaces. To assist The Park Catalog in entering orders properly, please fax or mail orders on your standard purchase order form. Quotes are good for 30 days.

GSA CONTRACT: GSA pricing is available on several items. Contact our sales department for specific information. SPECIFICATIONS: Due to The Park Catalog's continuous product improvement, we reserve the right to change specifications when necessary without notice.

PRICING: The Park Catalog strives to keep pricing as low as possible. However, should we encounter increases in our costs that are simply too large to absorb, we reserve the right to increase prices without notice.

TERMS: Approved accounts net 30 days. Initial order requires payment in full before shipment. A finance charge of 1-1/2% per month will be applied to all delinquent accounts. We accept VISA, MASTERCARD and AMERICAN EXPRESS. FREIGHT CHARGES: Terms of sale are F.O.B. factory. The Park Catalog will prepay and add the freight to the invoice if requested to do so. All weights are approximate.

Damages or loss in transit is the responsibility of the carrier, whether visible or concealed. It is the responsibility of the recipient to assure that the order is received complete. Before signing the delivery receipt, inspect the shipment immediately and completely. Note any damages or shortages on the bill of lading. Damage reports must be filed within 10 days. The Park Catalog is NOT responsible for damages or loss in transit. Title to all goods passes to the customer at the time of shipment. The Park Catalog will assist in filing claims if the freight arrangements were made by The Park Catalog at your request.

CANCELLATIONS AND RETURNS: Cancellations are only accepted with approval of The Park Catalog. No merchandise shall be returned without a Return Goods Authorization number which is issued by customer service. Any authorized merchandise must be carefully packed and received in saleable condition. A restocking charge of up to 25% will be applied to all returned goods when the error is not the fault of The Park Catalog. All returns must be shipped freight prepaid.

BOROUGH OF EBENSBURG LAKE ROWENA **DOG PARK**

Lake Rowena

Ebensburg, PA

COMPANY ADDRESS:

LANDSCAPE DESIGNER

PROJECT NAME:

Cambria County, PA

Park

CAMBRIA COUNTY

SAFETY WARNINGS & EQUIPMENT INSPECTION

Owners and installers please note these safety warnings and make use of this checklist on a regular basis. Follow installation instructions when erecting equipment.

Ground surfaces around equipment should be restored as needed. Concrete footings should never be exposed. Surface depth should comply with ASTM and CPSC specifications.

Check for and repair damage caused by wear or vandalism, a major factor in injury causing situations. All protruding bolts should be covered or cut off and finished smooth. Sharp edges on pipes should be capped or removed. Check for bent, broken, or severly worn pipe, and replace.

All equipment should be free of rust and repainted whenever necessary to deter rusting.

We provide our customers with layout sheets and installation instructions. Please keep on file the specifications sheet that contains the listing of every part used. Never add components not intended for use with this product.

Regular maintenance is necessary in this and all park and recreational equipment to insure the safety of the user.

Note. Proper maintenance of equipment requires regular tightening of all bolts, nuts, and setscrews. Note: Regular checking of all parts, castings, etc. should be made. If a part is broken or worn, it should be replaced immediatly.


Check to be sure all fittings are tight and that bars and pipes do not move. Replace all worn S-hooks. S-hooks must be completely closed. Failure to close S-hooks can result in serious injury to the user. NEVER reuse S-hooks.


Test for free movement of swing hanger and other moving attached parts.


Check for worn chains and replace them.


· A soft resilient surface should be placed under all swings extending at least twice the height of the top rail both front and back.


COMPONENTS T-01-08-0007 3/8" Zinc Plated Washer 5/16" x 1" Machine Bolt (Zinc, 3/8" Hex Nut (Zinc).

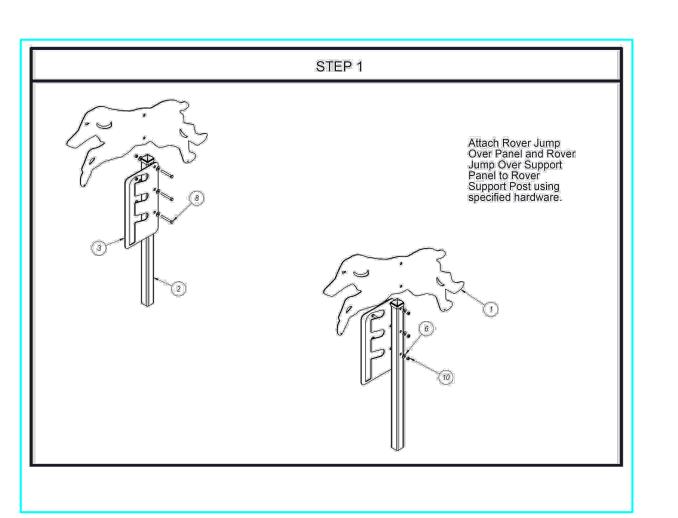

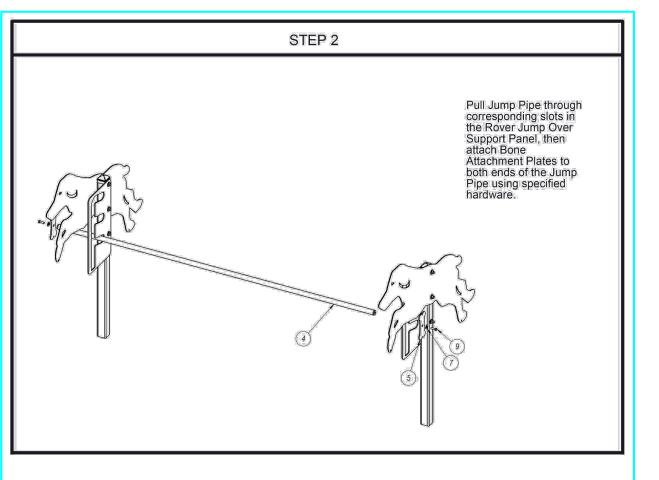

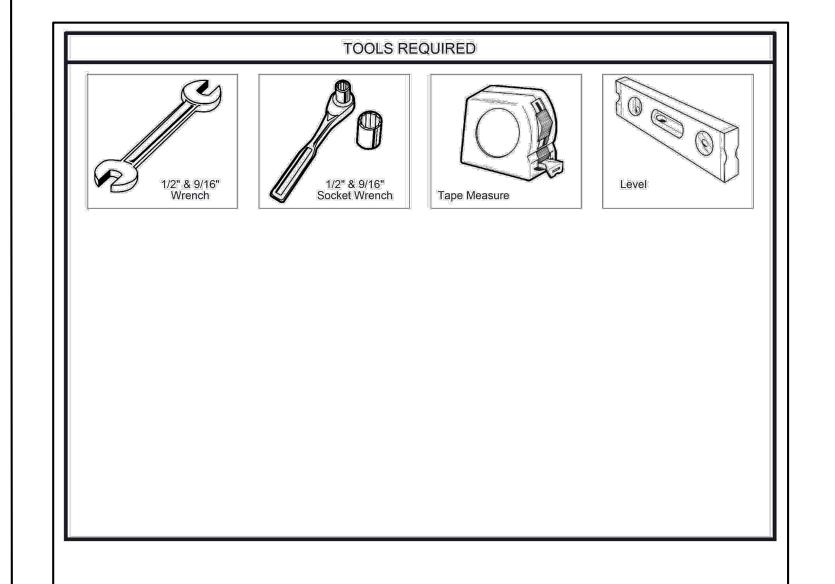

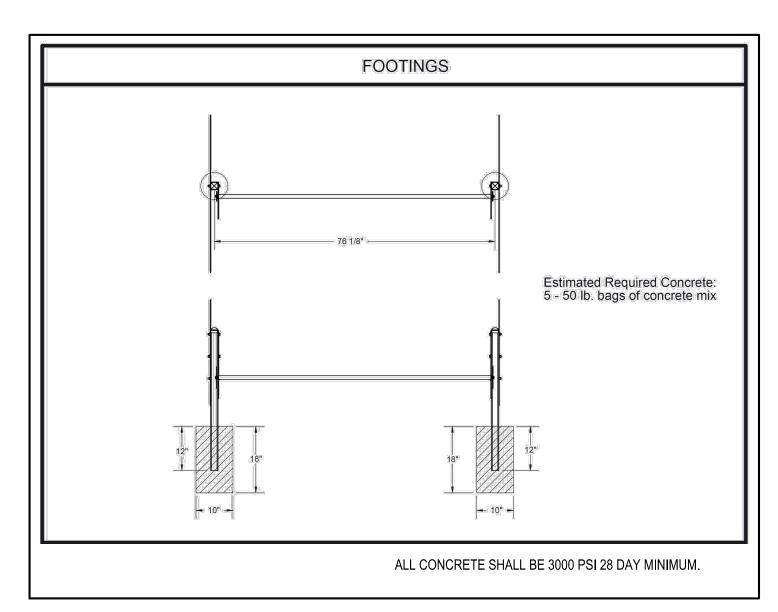

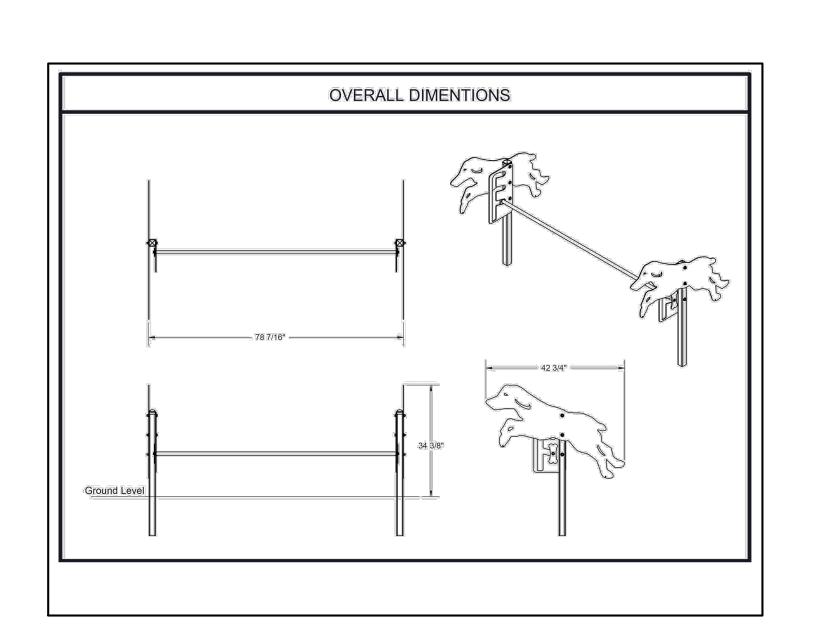

NOTE: THESE MANUFACTURER DETAILS ARE FOR INFORMATIONAL PURPOSES ONLY!! CONTRACTOR TO CONTACT THE SUPPLIER DIRECTLY FOR CONSTRUCTION AND INSTALLATION PURPOSES.


REV. DATE: DESCRIPTION 1-27-2022

PROJECT NO. EBG-01 AS SHOWN DRAWN BY: Dave Petrosky

Revised set: 1-12-23

DETAIL SHEET ROVER JUMP OVER SPECS


PRODUCED BY AN AUTODESK STUDENT VERSION

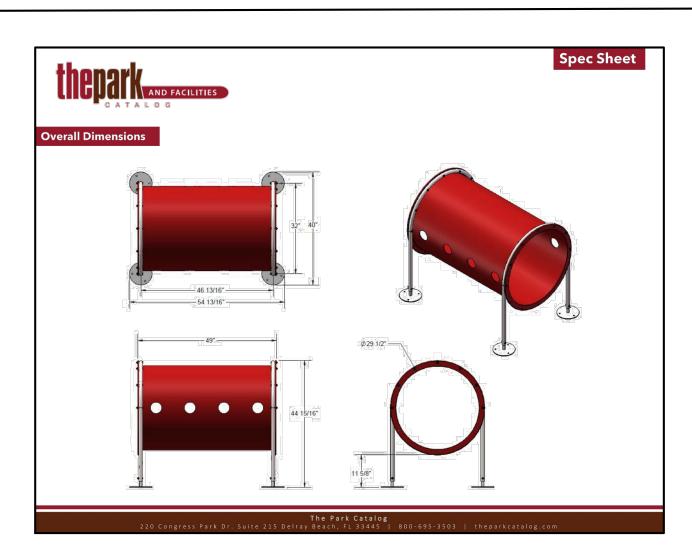



Red Bud, IL 62278 Phone: 618-282-8200 Fax: 618-282-8202

WARRANTY & TERMS

WARRANTY: 5 Year Limited Warranty on Thermoplastic/Canine coated elements

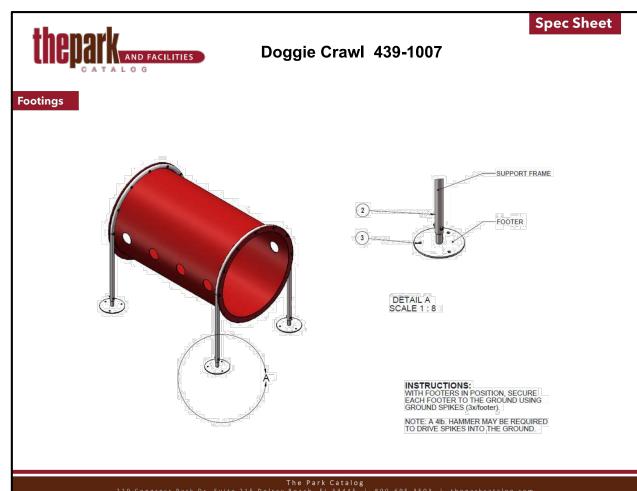

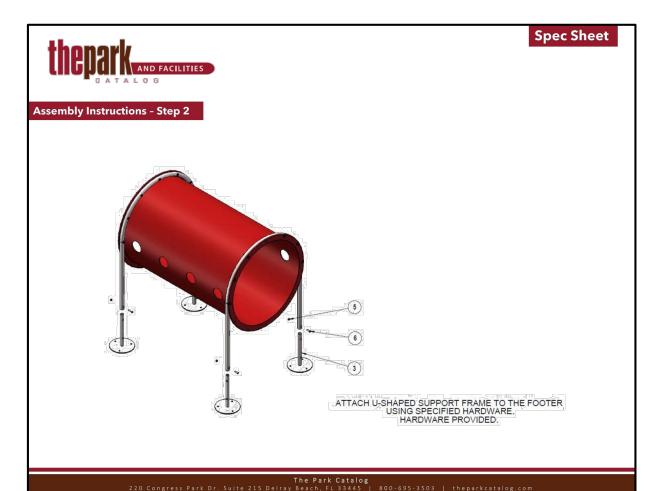

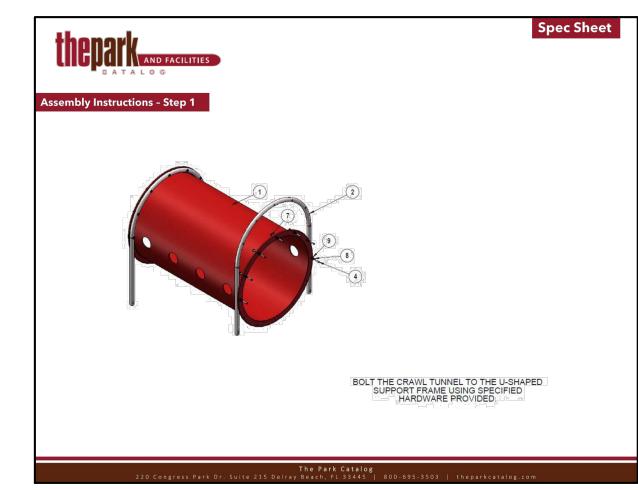

Lake Rowena Park


Ebensburg, PA Cambria County, PA **COMPANY ADDRESS:**

LANDSCAPE DESIGNER


PROJECT NAME:

BOROUGH OF EBENSBURG LAKE ROWENA **DOG PARK**


CAMBRIA COUNTY

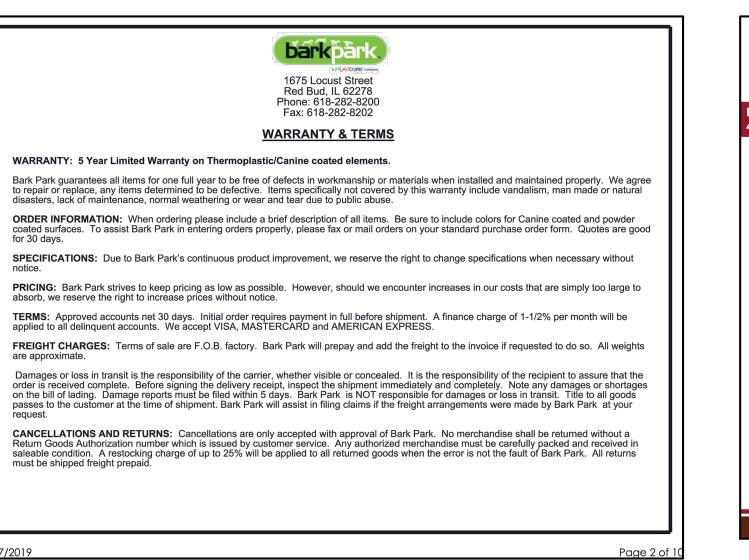





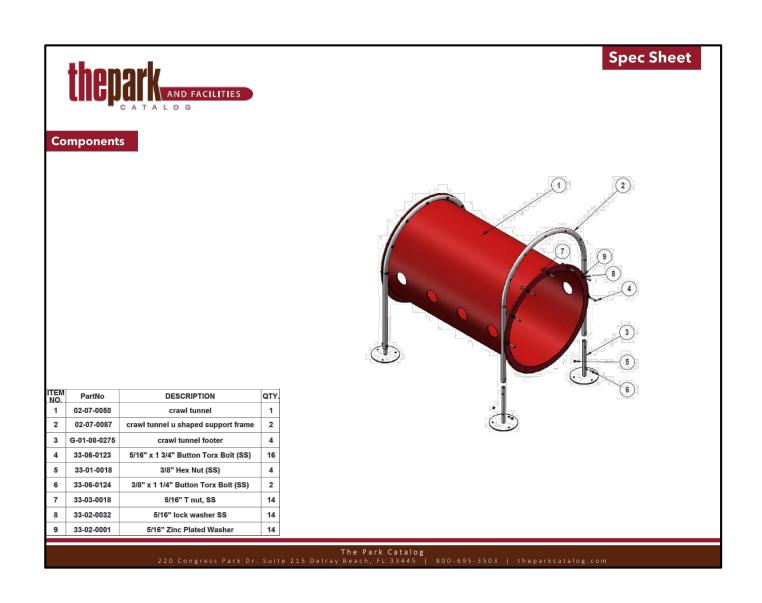


SUPPLIER FOR SPECIFICS IF NECESSARY. ALL CONCRETE SHALL BE 3000 PSI 28 DAY MINIMUM. CONTRACTOR MAY NEED TO CONTACT

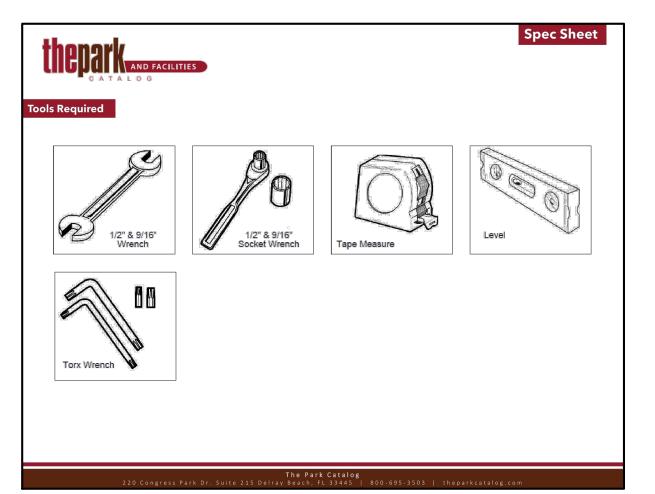

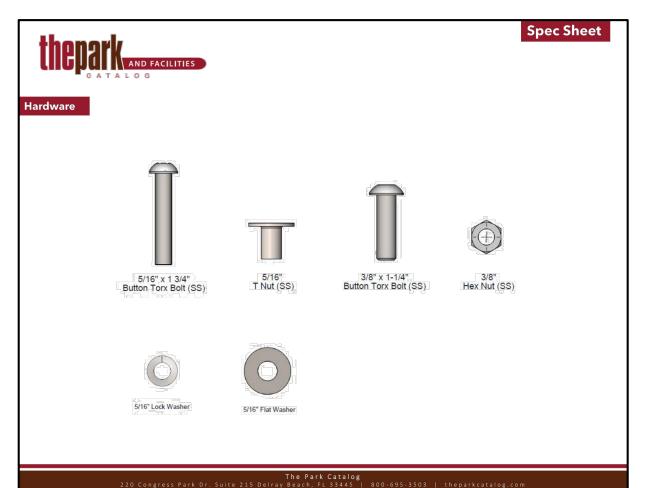

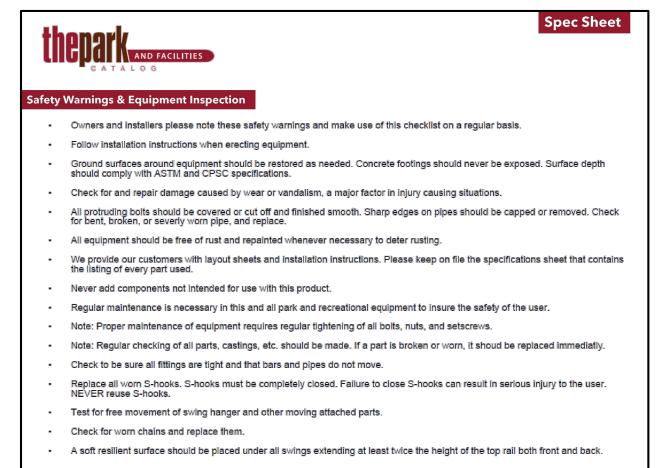

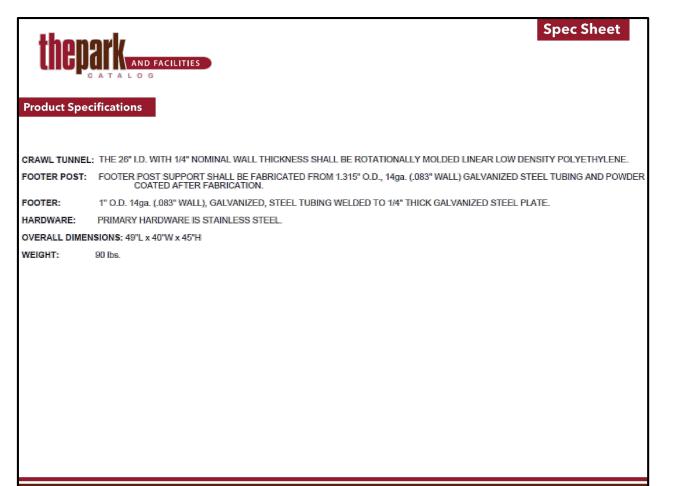

NOTE: THESE MANUFACTURER DETAILS ARE FOR INFORMATIONAL PURPOSES ONLY!! CONTRACTOR TO CONTACT THE SUPPLIER DIRECTLY FOR CONSTRUCTION AND INSTALLATION PURPOSES.

REV. DATE: DESCRIPTION 1-27-2022 PROJECT NO. EBG-01 DRAWN BY: Dave Petrosky RLA Revised set : 1-12-23 **DETAIL SHEET DOGGIE CRAWL**

SPECS

PRODUCED BY AN AUTODESK STUDENT VERSION

FINAL LAND DEVELOPMENT PLAN FOR LAKE ROWENA DOG PARK

Borough of Ebensburg Sheet Index

S1.00 Cover Sheet

S1.01 Site Plan

S1.01B Layout Plan

S1.02 Grading, Drainage and Utilities Plan Enlargement Plan of Entrance Area

S2.02 Detail Sheet Pet Fountains/Shower Etc.

Detail Sheet Dogipot Pet Station

Detail Sheet King of the Hill Specs

Detail Sheet Rover Jump Over Specs S2.06 Detail Sheet Doggie Crawl Specs

Erosion and Sedimentation Control Plans

Erosion and Sedimentation Control Details

Erosion and Sedimentation Control Details 2

General Notes

- 1. GENERAL SITE INFORMATION:
- 2. a.) Client/Owner The Borough of Ebensburg 300 West High Street Ebensburg, PA 15931 Phone: (814)472—8780
- 3. b.) Disturbed Area $-\pm 0.26$ Acres

- 5. b.) Disturbed Area ±0.26 Acres
 4. c.) Zoning "0—C" Open permitted use
 5. d.) Land Use Current: Existing Recreation Area including: Lake Rowena, 5 pavilions, Maintenance Building, Baseball Field, Volleyball Court, Restroom and Swing Set Proposed: Addition of a Dog Park around the North and West side of the Existing Hockey Rink
 6. e.) Building Setback Requirements No Setbacks Required for Dog Park with no large
- 7. f.) Construction Area: Proposed Dog Park
- 7. 1.) Construction Area: Proposed Dog Park
 8. g.) PA One Call: Design Serial No. 8-10-21 20212222296
 9. Source of Topography Information: From ground control surveys dated August 4, 2005. prepared by L. Robert Kimball and Associates. Additional Property Line verification for Takacs property competed by CPS Surveys dated April 5, 2021.
 10. Horizontal control is based on an arbitrary datum, holding magnetic bearing.
 11. Vertical control is based on NAVD88 datum. Elevations were established from USGS Benchmark


- 12. Site Contractor to contact the Pa One Call System at (800) 242—1776 at least 3 days prior to construction. Make final one call 90 days prior to construction.
- 13. Construction shall conform to all applicable state and local standards, specifications and
- 14. Existing pavement damaged by new construction shall be repaired per standard PA Dot Construction practices and specifications or Borough of Ebensburg criteria whichever is more
- 15. Prior to construction, Site Contractor shall verify from the site drawings and manufacturer specifications all dimensions, details and treatment for the Dog Park play apparatus and site
- 16. Erosion and sedimentation controls shall be provided where necessary prior to clearing, grubbing, and construction. A set of the Erosion and Sedimentation drawings shall be available on site.
- 17. Site Contractor shall locate all existing underground utilities and new crossings by test pits prior to construction in the vicinity of the utilities and contact the engineer if a problem arises prior to construction. Contact Josh Surkovich of the Borough with any questions. 18. Do not scale drawings.
- 19. Pipe lengths shown on the plans are measured in a horizontal plane from the center of structure to center of structure. Site Contractor to adjust pipe lengths to account for slope.
- 20. All subsurface drainage pipes shall have a minimum of 8" of cover or as shown to the top of
- 21. All subsurface drainage pipes shall be installed by the Ebensburg Borough unless otherwise noted. 22. The Site Contractor is responsible for the removal and disposal of trees and stumps by grinding.
- 23. A copy of the Erosion and Sedimentation Control Plan must be on—site at all times during the course of the project. 24. In order for the Erosion and Sedimentation Control Plan to function properly, the construction sequence staging must be followed throughout the construction of the project.
- 25. Contractor shall follow all OSHA requirements especially regarding equipment operation with
- regards to close proximity to overhead power lines.
- 26. If the Contractor encounters roots during excavation, they shall do their best to work around without damaging the roots, unless the roots interfere with the construction. If that's the case, the contractor shall cut the root in a clean, neat and precise cut as method of best practices.

 27. As part of this contract, The Borough of Ebensburg shall be responsible for the installation, material cost and construction of the described water line. It will be the responsibility
- of the contractor to coordinate the planning and timing, of the installation of the water line. The water line and the park itself is planned to be shut down in the winter months and closed in the evening hours. There are no lights and electricity planned for this project.

 28. The Site Contractor is responsible for providing the Borough of Ebensburg with a complete set of As—Built Plans with horizontal and vertical locations of all storm pipes, utilities and all apparatus
- and bench locations after the project has been completed. 29. Concrete Walks and Concrete Pads for all dog park benches, covered benches, and Dog apparatuses shown on details shall be provided as necessary, with a broom finish and sloped to drain from 1% to maximum 2%.
- 30. See Site Plan only for all identified items that are part of or not part of this project.
 31. All plans and specifications shall be adhere to the most recent version of PADOT PUB 408, unless specified otherwise.

Site Notes

- 1. Ebensburg Borough Deed Reference DBV 763/722 &.DBV 1515/ 158 Tax Map 25-20 Part of Parcel 112.
- 2. Flood Note: This property located in zone X (area of minimal flood hazard)Per FEMA Rate Map Number 4201C030305D with and effective date of June 12, 19 2012. There are no identifiable Wetland Area noted by the U.S. Department of the Interior, Fish and wildlife Commission. However the owner is responsible of verifying if wetlands exist.

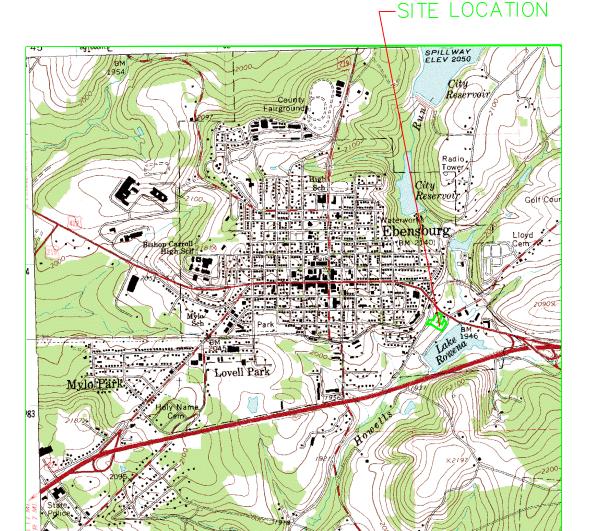

Site Location Map Scale: 1" = 2000'

PARKING	TARIII	ATION

Use	Reference	Criteria	Comments	Parking Required	Parking Provided
Hockey Rink	Borough of Ebensburg Zoning Ordinance	Provide 1 space for 4 customers at max capacity plus 1 space per 2 persons employed	10 players each Team plus (x2) pLus 2 coaches plus 2 Referees	6	6
		for peak period	1 part time employee	1	1
Hockey Rink	DCNR	Provide 1 space for every 2 available spectator seats	2 sets bleachers max seat capacity spectator seats = 27 seats each	22	22
Skate Board Area	Borough of Ebensburg Zoning Ordinance	customers at max capacity plus 1 space per 2 persons employed for	Maximum users planned are 41* for 6,829 sf	10	10
		peak period. Provide 1 space for every	no employees	0	0
	DCNR	2 available spectator seats	Spectator Bench area. Assume 8 spectator seats Maximum	4	4
Lake/Fishing/ Pavillion	Time—Saver Standards Section 520—3	2.5 persons per automobile	(Borough) use 50 people per day average	20	20
New Dog Park	recommendations and	No quantitative data available readily accessible, convenient close to site, provide ADA Access to site.	Recommended Dog Park size is 1/2—1Ac Provided 10 spaces Per Dog Park. Total Approximately 1.58 Ac	10	10
TOTAL PARKIN	G REQUIRED	10 spaces =		73	
TOTAL PARKIN	G PROVIDED	63 existing spaces Plus 10	new spaces =		73

* NOTE FROM DCNR SKATING MANUAL - USE 45 SKATERS FOR 7,500 SF

CAMBRIA COUNTY PA LIST OF PUBLIC UTILITIES

SANITARY SEWER EBENSBURG, PA 15931 PHONE: 814-207-4027

PHONE: 814-207-4027

ATTN: JOSH SURKOVICH

PHONE: 814-269-6333

ATTN: RICK FINK

TELEPHONE 1119 16TH 3RD FLOOR ATTN: JERRY DOWNING

Rfink@firstenergycorp.com

CABLE TELEVISION CARROLLTOWN, PA 15722 PHONE: 814-344-8055 EXT. 134 ATTN: BILL ICKES

Legend of Existing/ Proposed Symbols And Abbreviations

LEGEND		
ITEM	EXISTING	PROPOSED
BITUMINOUS PAVEMENT (12" FULL DEPTH)		
4" CONCRETE SIDEWALK	N/A	
3.5' WIDE WALKING PATH WITH AASHTO # 10 SURFACE	N/A	
SURVEY CONTROL POINT	<u>A</u>	N/A
BENCHES	N/A	
DOG PLAY APPARATUS	N/A	
GRASS AREA ON EROSION CONTROL PLAN	N/A	
FENCE LINE	— х —	
PAVEMENT MARKING		
STORMWATER INLET		-
STORMWATER PIPE	====	
GUARD RAIL	-0	N/A
ELECTRIC BOX	EB	N/A
EXISTING TREES		N/A
WATER LINE	w	
SANITARY SEWER LINE	SAN	, N/A
EXISTING MONITORING WELL	W	N/A
SPOT ELEVATIONS	51.59×	1950.2 X
GROUND CONTOURS	_	—1955 —
INLET PROTECTION	N/A	0
LIMIT OF DISTURBANCE	N/A	C_{-}
SILT SOCK	N/A	SS SS
DIRECTION OF DOWNWARD SLOPE	N/A	2%_
EXISTING IRON PIN	IPo	N/A
ELECTRICAL CONDUIT/CABLE	—E—	N/A
ELECTRICAL GUY WIRE	>	N/A
ELECTRICAL POWER POLE	<u></u>	N/A

Professional Landscape Architect Certification

I David Petrosky, a Registered Landscape Architect In the Commonwealth of Pennsylvania, hereby certify that the Improvements shown herein, have been designed in accordance with the Professional Standard of Care.

Registration Number LA001189E

Expiration Date 5-31-2023

Date: 1--27-2022

Lake Rowena Park


Ebensburg, PA Cambria County, PA **COMPANY ADDRESS:**

LANDSCAPE DESIGNER

PROJECT NAME

BOROUGH OF EBENSBURG LAKE ROWENA **DOG PARK**

CAMBRIA COUNTY

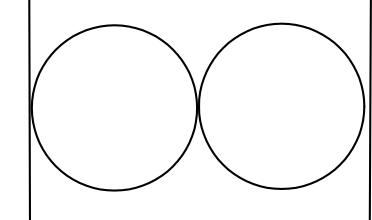


REV. DATE: DESCRIPTION

ISSUE: 1-27-2022 PROJECT NO. Ebg. 01 As Shown DRAWN BY: Dave Petrosky, RLA

Revised Set 1-12-23

COVER SHEET

Petro file/Documents/DogParkLake/FinalPlotsandDwgs2—1—22onThumbDrive/RonsetofDwgs/RevisdSet1—12—23 Original DWG Files copied to Phil Sutton, of the Ebensburg Rotary on January 2023.

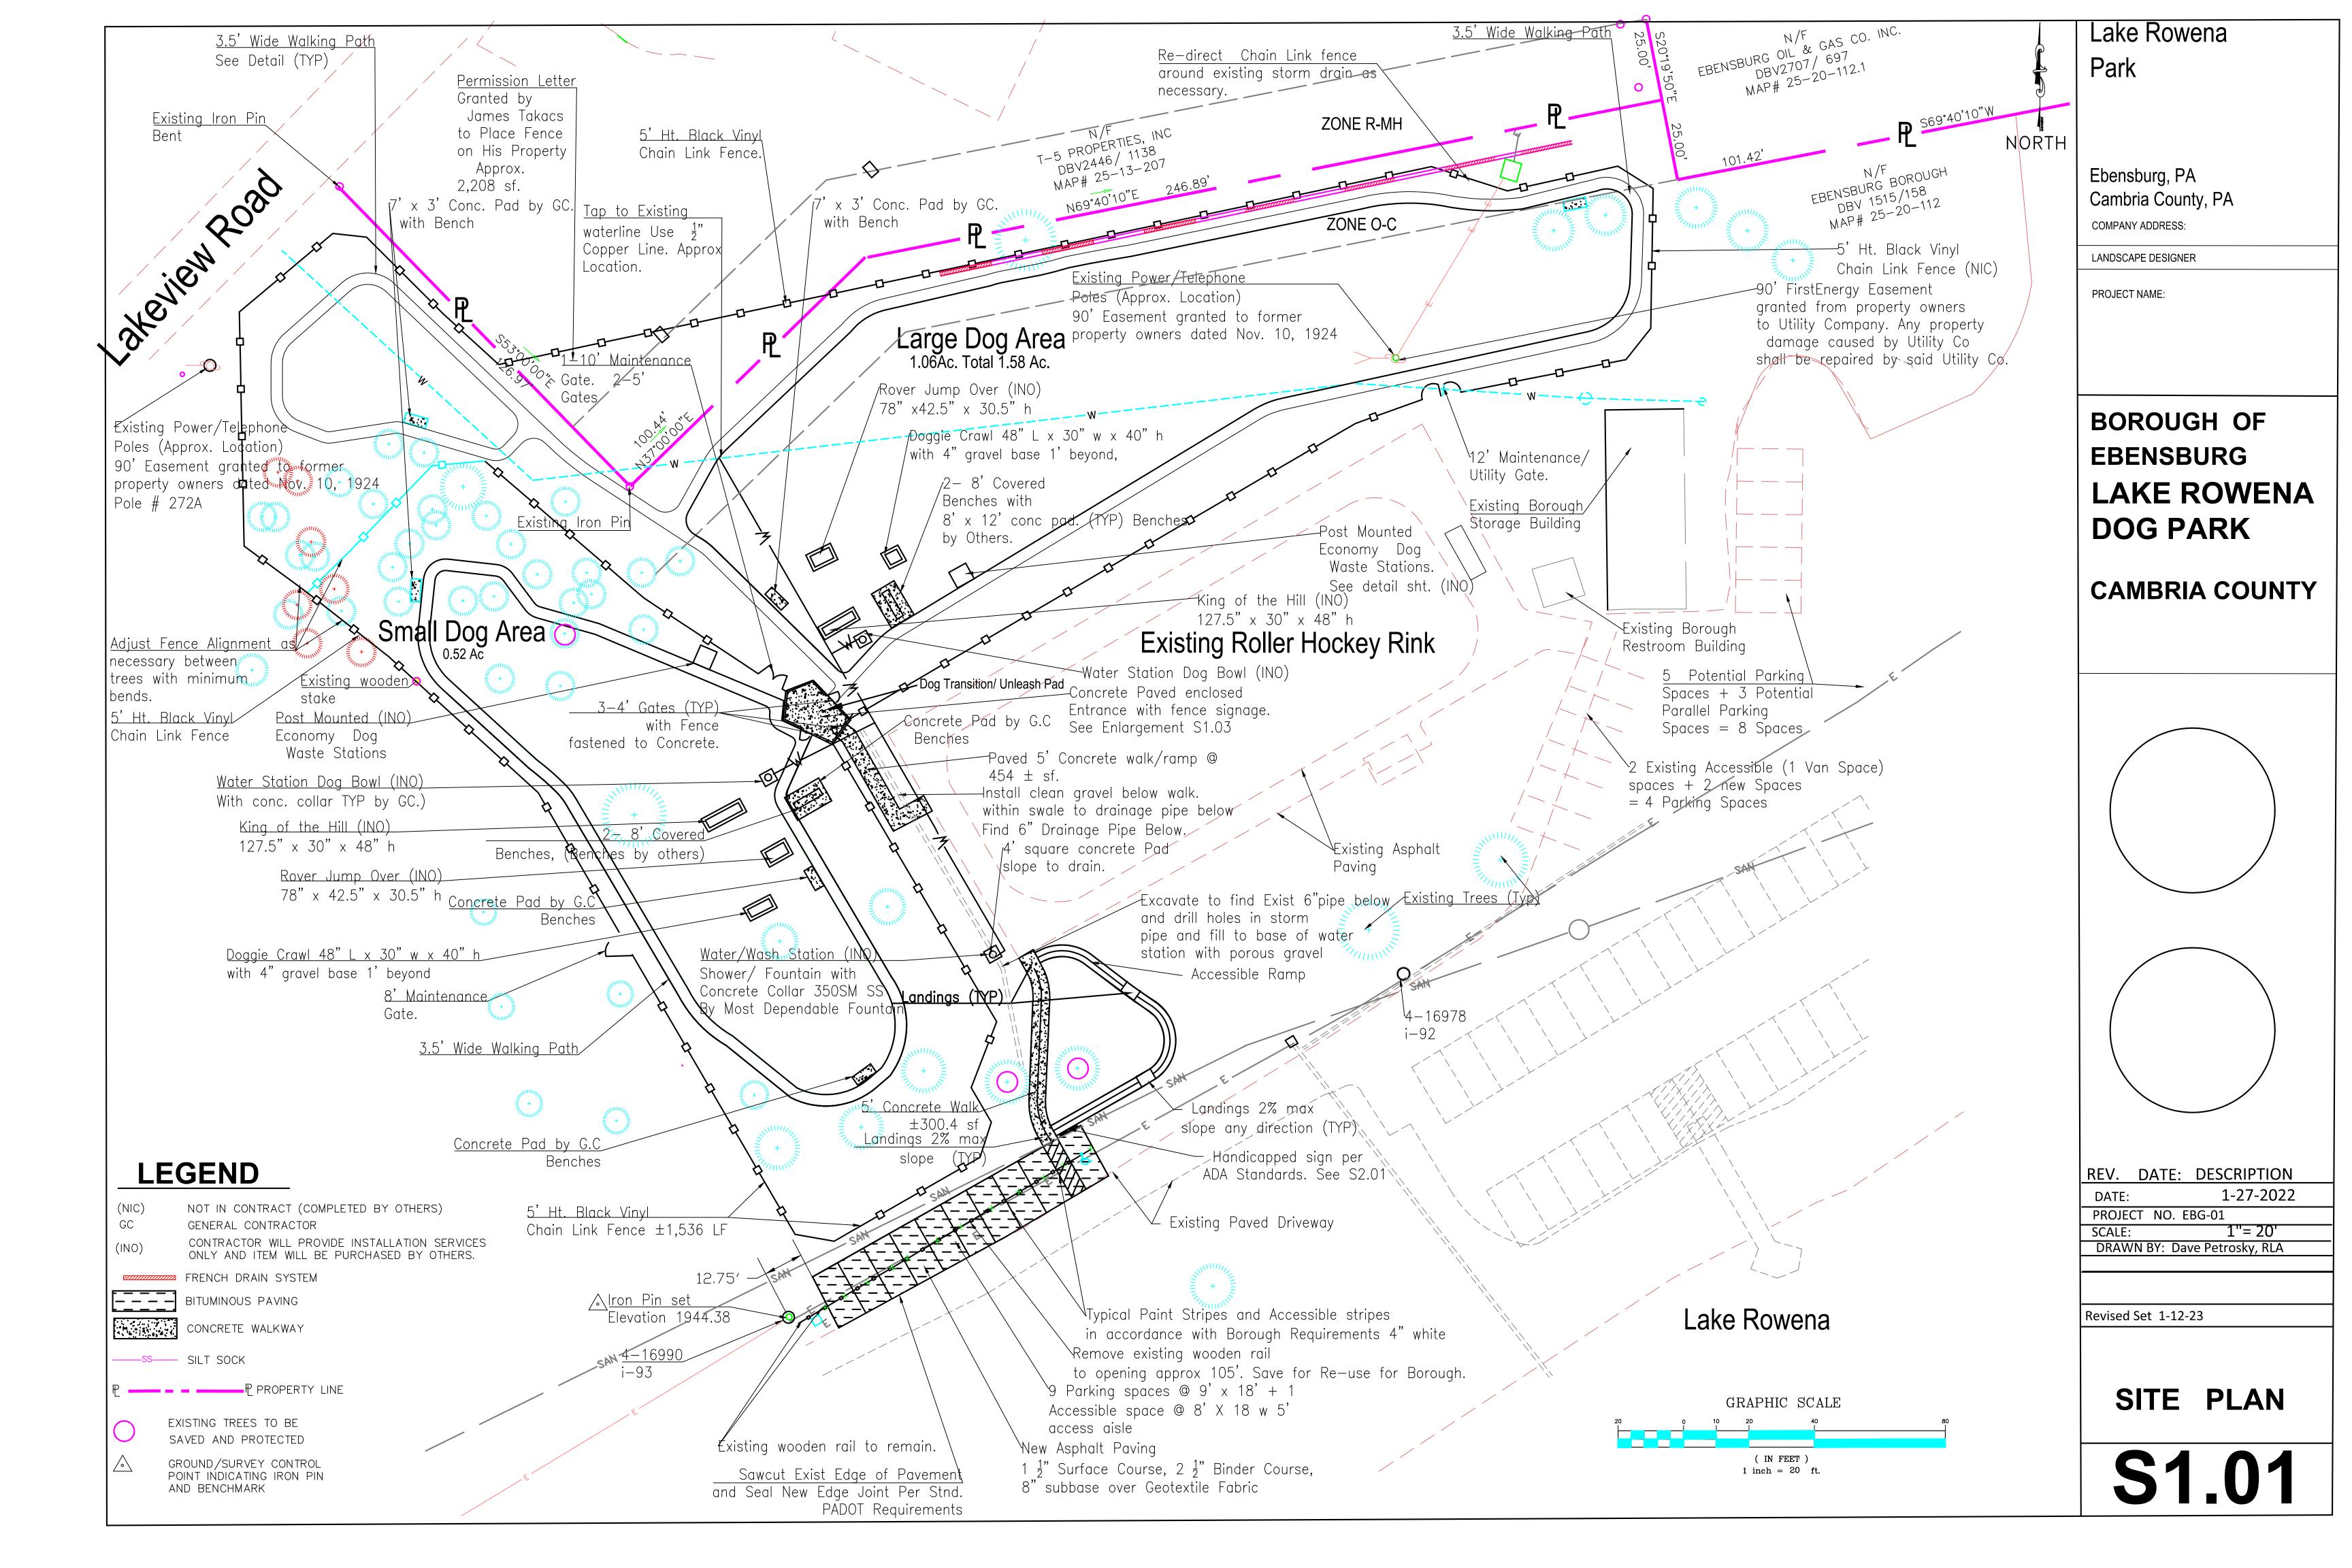

<u>Narative</u>

1. Dave Petrosky, RLA, is preparing the design for a new Dog Park Design on the North/West/South side of the existing Roller Hockey Rink that will be constructed at the Lake Rowena Recreation Park located in the Borough of Ebensburg, Cambria County, Pennsylvania. The Lake Rowena Rec Park bounds the Dog Park on the East, South and West. The site is bounded on the North by a Veterinary Hospital that is zoned R-MH, Multiple Household Residential. The site's main access will be from High Street where there is currently a traffic light

to help control ingress and egress movements. The land is zoned "O-C" Open Space Conservancy. The use is allowed by Borough ordinance. The total disturbed area is approximately 0.26 acres. The disturbed area includes the walking path, a 2' wide area for each storm pipe and the two disturbed areas. This plan shall not be considered all —inclusive and the contractor shall take any necessary to prevent sediment from leaving the site.

Any topsoil stockpiles, excess excavation stockpiles, and any graded area on which work ceases for 7 or more days shall have interim soil erosion and sedimentation control measures performed on them. These measures consist of temporary seeding and mulching of the stockpiles and the installation of the silt fence. All areas not to be paved shall be stabilized by applying final seed mixture and mulching as soon as practical after final earthmoving is complete. All areas to be paved will have stone base subbase applied as soon as possible after reaching final grade. The permanent cover shall be accomplished within 7 days after final grading operations have been

- A. The Contractor will be required to implement the Erosion and Sedimentation Pollution Control Plan as shown prior to begining any work.
- B. As an option, The Contractor may submit his own Erosion and Sedimentation Control Plan to the Cambria County Conservation District for approval.
- C. The Contractor will be required to implement measures indicated on his approved plan as a minimum requirement. However, the Contractor will be responsible for adding additional measures if the ones indicated prove to be inadequate, at no additional cost to the Department.
- D. Lake Rowena has been used for recreational purposes for several decades and the present and future plans for the area will be as
- E. The contractor shall plan for all construction waste disposal in an appropriate manner and use recycled materials whenever possible. The contractor shall also recycle waste when applicable and appropriate for the project.
- F. The site drains to Lake Rowena and eventually drains to the unamed tributaries of the Little Conemaugh River. These tributaries are designated as CWF (Cold Water Fishes) within Chapter 93.

<u>Submittals</u>

- A. Contractor will be required to submit catalog cuts/technical data to the Borough Representative Inspector, that shows that the erosion and sedimentation pollution control materials meet the specifications.
- B. Contractor shall also submit to the Borough Representative Inspector for approval a Staging of Earth Moving Activities Schedule which explains the sequence of work with regards to Erosion and Sedimentation Control. Similar of the following:

SEQUENCE OF STAGES OF CONSTRUCTION ACTIVITIES

- The Contractor will: 1. Install E&S measures first to protect existing trees including Inlet Protection and Filter Sock first to prevent the lake from receiving any sediments from
- 2. Clear and grub all trees and brush interfering with the work, which is minimal. 3. Contractor shall strip topsoil promarily in the proposed parking area and walks, and istall Filter Sock as the BMP along the down slope as shown on the plans.
- 4. Begin excavation and install storm drain system from the existing inlet and. westward and install new storm inlet proceeding northward for the under drains. Install the French drain pipe and continue installing the entire under drain system.
- 5. Regrade the area to blend into the existing topography.
- 6. Topsoil, Seed and mulch any disturbed areas. This will occur as segments are completed. 7. Temporary Interim stabilization measure BMP's such as installing silt sock
- and seeding with an erosion resistant perennial species shall be used until the time a uniform 70% vegetative cover has been established of which is considered as a permanent stabilization. 8. Complete construction of Dog Park areas.
- 9. Remove All E&S temporary control measures (Silt Sock and RCE etc.).
- 10.The Construction Entrance (RCE) is shown at 40' long not the 50' wide as the standard shows. However because of the shotened length due to the presence of the existing tree, the RCE may be shortened to 40 'long and 20' wide, but the contractor should be prepared to clean the existing drive surface as necessary.
- 11.The Contractor shall be responsible for restoring and repairing any damaged pavement that occurs during construction, and shall keep all existing traffic area clean.

Erosion and Sedimentation Pollution Control and Seeding & Mulching <u>Materials</u>

- A. Silt Sock shall meet the requirements of Section 865.2, Penn DOT (the Department) 408/2003.
- B. Filter bag to be used for dewatering shall meet the following:
- Typical Properties ASTM D3776 8.3 oz./yd. ASTM D1777 120 mils Thickness ASTM D4632 240 lbs. Grab Tensile ASTM D4632 50% Grab Elongation at Break ASTM D4833 115 lbs. Puncture Resistance ASTM D4533 100 lbs. Trapezoidal Tear ASTM D3788 350 lbs. Mullen Burst ASTM D4491 105 gpm/ft. Water, Flow Rate ASTM D4491 1.7 sec.-1 Permittivity ASTM D4355 85% str. ret. UV Resistance 15 ft. x 13.25 ft. (approximate) Bag Dimensions
- C. <u>Seed Mixtures</u>

Penn DOT 408/2003.

- 1. Seed mixtures shall be in accordance with Section 804.2(b)
 - a. Formula E—Temporary Erosion Control, 45 lbs/acre March 15 to October 15
 - b. Slopes flatter than 3:1 Formula B-Permanent Seeding, 120 lbs/acre March 15 to June 1 , August 1 to October 15
 - c. Ditches/Swales Formula W-Permanent Seeding, 60 lbs/acre April 1 to June 15

August 16 to September 16 D. Mulch materials

- 1. Mulch shall be hay or straw and shall be
- in accordance with Section 805.2, Penn DOT 408/2003. 2. Mulch shall be applied at a rate of 3 ton/acre
- 3. Mulch Binders shall be in accordance with Section 805.2(b),
- Penn DOT 408/2003. 4. Mulch binders shall be applied at a rate of 775 lbs/acre.

E. Soil Supplements

- 1. Soil Supplements shall be in accordance with Section 804.2(a). Penn DOT 408/2003.
- 2. Pulverized Agricultural Limestone shall be applied at a rate of 4 ton/acre.
- 3. 10-20-20 Analysis Commercial Fertilizer shall be applied
- 4. Slow-Release Nitrogen Fertilizer shall be applied at the rates as indicated in Section 804.3(c), Penn DOT 408/2003.

F. Topsoil Topsoil required can be on site material or from outside the project, all topsoil shall meet the requirements

of Section 802.2, Penn DOT 408/2003.

- A. Erosion checks shall be placed prior to beginning any work and shall be maintained throughout the construction period.
- B. The Contractor shall build, maintain and operate all temporary diversions and protective works needed to divert surface water through or around any excavations.
- C. All drainage from bared areas shall be prevented from entering waters of the Commonwealth until sediment has been allowed
- D. Natural vegetation shall not be removed from any areas until the Contractor is prepared to conduct subsequent operations in that area.
- E. Excavations shall be dewatered and kept free of standing or running water as needed for proper construction. The Contractor shall furnish, install, operate and maintain all methods and equipment needed to perform any dewatering. Dewatering methods that cause a loss of fines will not be permitted. See wetlands filter bags.
- F. If at any time it is anticipated that work on any segment of the Project will be halted for more than 20 days, the area bared shall be protected from erosion by temporary seeding and mulching. When work is resumed, all temporary protective matter shall be removed at no additional cost to the Department
- G. Immediately upon completion of any segment of the Project, that segment shall be finished graded and seeded. If completion occurs at a time when seeding would be unsatisfactory, temporary seeding may be applied with the permanent seeding applied when satisfactory seeding can be achieved.
- H. Maintain all erosion and sedimentation control measures while they are in place. Remove and replace damaged geotextile fabric. Replace filter sock if it becomes displaced from the control areas. Periodically remove buildups of sediment by removing the sediment and disposing of it properly in spoil areas. Do not discharge the sediment into the lake or store it where it can be washed into the lake. Replace Filter bags if used, when the buildup of sediment does not permit ready passage of water.
- Remove the erosion and sedimentation control measures when they are not longer required for protection. Approval must be received from the Department prior to removal of control measures. The areas shall be restored to conditions meeting the requirements of the final construction, or if the area is outside the limit of a construction feature, it shall be restored to the conditions that existed prior to the installation of the control measures. All accumulated sediment shall be removed

5. Filter Bag For Dewatering and/or bypass pumping

by properly disposing of it in spoil areas.

- A. The filter bag should trap particles larger than 150 microns.
- B. The designed maximum pumping rate for the filter bag, of 1/2 the maximum as specified by the manufacturer, shall not be exceeded.
- C. The filter bag should not be used after it is half filled with sediment. The debris in the filter bag shall be cleaned and dispersed on site after the filter bag is about half filled.
- D. The filter bag should be placed on a stable or well-vegetated area and should not be used on any slope greater than 5 Wherever a well-vegetated area is not available, a geotextile underlayment or an aggregate bed should be used.
- E. The filter bag should discharge into a stabilized area, stabilized watercourse, or stream channel. It should not be allowed to flow down any steep bank.
- F. The pump discharge pipe or hose should securely clamp and be watertight into the bag.

6. Finish Grading

A. Contractor shall blend all finished grades in with the adjacent existing topography to provide smooth transitions. Finished surface will be as approved by the Department.

7. <u>Topsoil Placement</u>

A. Topsoil shall be placed as necessary to establish grass growth on all disturbed areas.

8. <u>Seed Bed Preparation</u>


- A. Slopes Flatter than 3:1 Seed bed preparation shall be as per Section 804.3(b), Penn DOT 408/2003.
- B. Slopes 3:1 and Steeper After the areas to be planted have been brought up to grade and approved by the Department, the slopes shall be scarified in a horizontal direction to sufficiently break up the surface crust for bedding the plants.

9. Soil Supplements, Seeding and Mulching


- A. Soil supplements, seeding and mulching application rates and construction shall be as per Section 804.3 and 805.3 Penn DOT 408/2003 except rates shall be as indicated this Dwg.
- B. After seeding and mulching operations have been completed, barricades and approved warning signs shall be erected as required to provide protection against traffic and trespass. Excess material from seeding and mulching operations, and all debris, shall be cleaned up and disposed of off the site.

10. <u>Maintenance Program</u>

- A. The Contractor shall follow the maintenance program as outlined in this Section.
- B. The erosion and sedimentation control measures will be checked on a daily basis and after any storm events. Refer also to maintenance procedures on the standard Drawings. Generally, filter socks should not be used for more than three months, sediment should be removed when accumulations reach 1/3 the above ground height of the barrier and any section of bale, if used, which has undermined or topped must be immediately replaced with a rock filter outlet. Silt fence should be cleaned when accumulations reach 1/2 the above ground height of the fence and any section of fence that has been undermined or topped must be immediately replaced with a rock filter outlet. Rock filters should be removed when clogged with materials. Materials must be washed completely free of all foreign materials or new rock used to rebuild the filter.

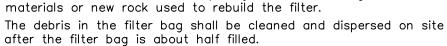


- C. Any damage and areas which need cleaned out will be reported and addressed in a timely manner.
- D. All material collected from the control measures and facilities will be placed in fill areas and seeded as
- E. The maintenance program will remain in effect until all control measures are removed.
- F. Reseeding and Repair During the maintenance period, The Contractor shall maintain the areas completed in accordance with the requirements of Section 804.3(J), Penn DOT 408/2003 until all work under the contract has been completed and has been accepted by the Department. The maintenance shall consist of refilling rain-washed gullies, with acceptable topsoil and fill materials, reseeding, reapplying soil supplements and mulch, as directed by the Department.

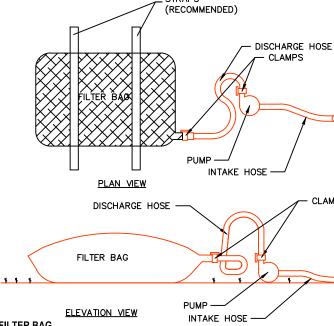

GEOTEXTILE FILTER BAG A. THE BAG SHALL BE INSTALLED ON A VERY SLIGHT SLOPE SO INCOMING WATER FLOWS DOWNHILL THROUGH THE BAG

- WITHOUT CREATING MORE EROSION. THE NECK OF THE FILTER BAG SHALL BE TIGHTLY STRAPPED (MINIMUM TWO STRAPS) TO THE DISCHARGE HOSE.
- THE BAG SHOULD BE PLACED ON AN AGGREGATE OR HAY BALE BED TO MAXIMIZE WATER FLOW THROUGH THE ENTIRE
- THE FILTER BAG IS FULL WHEN IT NO LONGER CAN EFFICIENTLY FILTER SEDIMENT OR PASS WATER AT A REASONABLE RATE. E. FLOW RATES VARY DEPENDING ON THE SIZE OF THE DEWATERING DEVICE, AMOUNT OF SEDIMENT DISCHARGED INTO THE DEWATERING DEVICE, THE TYPE OF GROUND, ROCK, OR OTHER SUBSTANCE UNDER THE BAG AND THE DEGREE OF THE SLOPE ON WHICH THE BAG LIES. THE FILTER BAG SHOULD BE SIZED TO ACCOMMODATE THE ANTICIPATED FLOW RATES FROM THE TYPE OF PUMP USED. TYPICALLY FILTER BAGS CAN HANDLE FLOW RATES OF UP TO 1000 GALLONS PER MINUTE. BUT IN
- ALL CASES FOLLOW THE MANUFACTURERS RECOMMENDATIONS FOR FLOW RATES. F. USE OF EXCESSIVE FLOW RATES OR OVERFILLING THE DEWATERING DEVICE WITH SEDIMENT WILL CAUSE RUPTURES OF THE BAG OR FAILURE OF THE HOSE ATTACHMENT STRAPS
- THE FILTER BAG CAN BE LEFT IN PLACE AFTER CUTTING THE TOP OFF AND SEEDING AND MULCHING THE ACCUMULATED SEDIMENT OR REMOVED AND DISPOSED OF OFFSITE IN AN APPROVED LANDFILL. H. EACH STANDARD DEWATERING DEVICE SHALL HAVE A FILL SPOUT LARGE ENOUGH TO ACCOMMODATE THE DISCHARGE HOSE.
- USE TWO STAINLESS STEEL STRAPS TO SECURE THE HOSE AND PREVENT PUMPED WATER FROM ESCAPING WITHOUT BEING I. THE DEWATERING DEVICE SHALL BE A NONWOVEN BAG, WHICH IS SEWN WITH A DOUBLE NEEDLE STITCHING USING A HIGH
- J. THE DEWATERING DEVICE SEAMS SHALL HAVE AN AVERAGE WIDE WIDTH STRENGTH PER ASTM D 4884 OF 100 LB/IN (1.15
- K. THE GEOTEXTILE FABRIC SHALL BE A NONWOVEN FABRIC WITH THE FOLLOWING PROPERTIES:

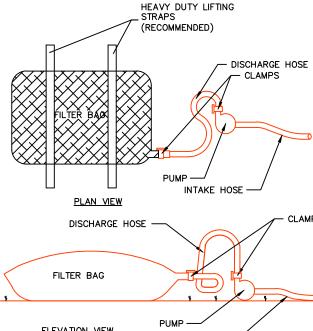

BOROUGH OF EBENSBURG LAKE ROWENA **DOG PARK**

Lake Rowena

Park

Ebensburg, PA


COMPANY ADDRESS:

LANDSCAPE DESIGNER

PROJECT NAME:

Cambria County, PA

CAMBRIA COUNTY

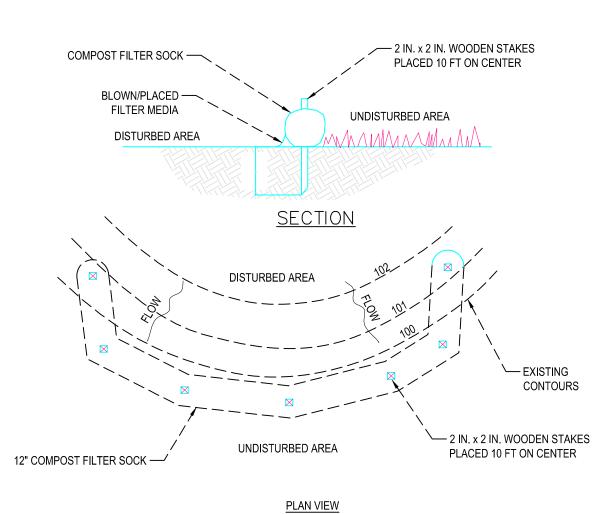

NOTES:

- 1. SILT SOCK SHALL MEET STANDARDS OF SECTION 865.2, PENN DOT (THE DEPARTMENT) 408/2003.
- 2. COMPOST FILTER SOCK SHALL BE PLACED AT EXISTING LEVEL GRADE. BOTH ENDS OF THE BARRIER SHALL BE EXTENDED AT LEAST 8 FEET UP SLOPE AT 45 DEGREES TO THE MAIN BARRIER ALIGNMENT. MAXIMUM SLOPE LENGTH ABOVE ANY BARRIER SHALL NOT EXCEED THAT SPECIFIED FOR THE SIZE OF THE SOCK AND THE SLOPE OF ITS TRIBUTARY AREA.
- 3. TRAFFIC SHALL NOT BE PERMITTED TO CROSS COMPOST FILTER SOCKS.
- 4. ACCUMULATED SEDIMENT SHALL BE REMOVED WHEN IT REACHES 1/2 THE ABOVE GROUND HEIGHT OF THE BARRIER AND DISPOSED IN THE MANNER DESCRIBED ELSEWHERE IN THE PLAN.
- 5. COMPOST FILTER SOCKS SHALL BE INSPECTED WEEKLY AND AFTER EACH RUNOFF EVENT. DAMAGED SOCKS SHALL BE REPAIRED ACCORDING TO MANUFACTURER'S SPECIFICATIONS OR REPLACED WITHIN 24 HOURS OF INSPECTION.
- 6. BIODEGRADABLE COMPOST FILTER SOCKS SHALL BE REPLACED AFTER 6 MONTHS; PHOTODEGRADABLE SOCKS AFTER 1 YEAR. POLYPROPYLENE SOCKS SHALL BE REPLACED ACCORDING TO MANUFACTURER'S RECOMMENDATIONS.
- 7. UPON STABILIZATION OF THE AREA TRIBUTARY TO THE SOCK, STAKES SHALL BE REMOVED. THE SOCK MAY BE LEFT IN PLACE AND VEGETATED OR REMOVED. IN THE LATTER CASE, THE MESH SHALL BE CUT OPEN AND THE MULCH SPREAD AS A SOIL

SS

REV. DATE: DESCRIPTION

1-27-2022 PROJECT NO. EBG-01

N/A

DRAWN BY: Dave Petrosky, RLA

E & S Comments addressed 2-7-2022 Revision Set 1-12-23

EROSION AND SEDIMENTATION CONTROL DETAILS

CUBIC YARDS OF TOPSOIL REQUIRED FOR APPLICATION AT VARIOUS DEPTHS

DEPTH (in)	PER 1,000 SQUARE FEET	PER ACRE
1	3.1	134
2	6.2	268
3	9.3	403
4	12.4	537
5	15.5	672
6	18.6	806
7	21.7	940
8	24.8	1,074

GRADED AREAS SHOULD BE SCARIFIED OR OTHERWISE LOOSENED TO A DEPTH OF 3 TO 5 INCHES TO PERMIT BONDING OF THE TOPSOIL TO THE SURFACE AREAS AND TO PROVIDE A ROUGHENED SURFACE TO PREVENT TOPSOIL FROM SLIDING DOWN SLOPE.


TOPSOIL SHOULD BE UNIFORMLY DISTRIBUTED ACROSS THE DISTURBED AREA TO A DEPTH OF 4 TO 6 INCHES MINIMUM. SPREADING SHOULD BE DONE IN SUCH A MANNER THAT SODDING OR SEEDING CAN PROCEED WITH A MINIMUM OF ADDITIONAL PREPARATION OR TILLAGE. IRREGULARITIES IN THE SURFACE RESULTING FROM TOPSOIL PLACEMENT SHOULD BE CORRECTED IN ORDER TO PREVENT FORMATION OF DEPRESSIONS UNLESS SUCH DEPRESSIONS ARE PART OF THE PCSM PLAN.

TOPSOIL SHOULD NOT BE PLACED WHILE THE TOPSOIL OR SUBSOIL IS IN A FROZEN OR MUDDY CONDITION, WHEN THE SUBSOIL IS EXCESSIVELY WET, OR IN A CONDITION THAT MAY OTHERWISE BE DETRIMENTAL TO PROPER GRADING AND SEED BED PREPARATION. COMPACTED SOILS SHOULD BE SCARIFIED 6 TO 12 INCHES ALONG CONTOUR WHEREVER POSSIBLE PRIOR TO SEEDING.

TOPSOIL APPLICATION NOTES

	DISTURBED SOILS							
SYMBOL	NAME	SLOPE (%)	DRAINAGE CLASS	DEPTH TO BEDROCK	DEPTH TO SEASONAL HIGH H20 TABLE (FT)	PERMEABILITY (IN/HR)	CAPABILITY SUB CLASS	HYDROLOGIC SOIL GROUP
WaB	Wharton silt loam	3-8 %	Mod. Well Drained	>48"	16-36"	0.6-2.0	III	С
BtB	Brinkerton Soils	3-8 %	Poorly Drained	>60"	0-0.5	0.6-2.0	III e	D
			S	PECIAL NO	TES			
CROP PR	TATIONS FOR THE ABOVE S ODUCTION. SEE BELOW FO R THE SOILS LOCATED ON	R SPECIF	TIC LIMITATIONS. THE	SE LIMITATION	ONS WILL BE OVERCOME	BY IMPLEMENTIN	NG A PROPER	PLANTING
			CAPABILITY/S	UBCLASS	CLASSIFICATION			
	HAVE SEVERE LIMITATIONS		REDUCE THE CHOICE	OF PLANTS	OR THAT REQUIRE SPEC			
	S HAVE VERY SEVERE LIMIT					SPECIAL CONSE	RVATION PRAC	TICES OR BO
e –	Main risk is erosion III -	· Main ris	k is SEVERE WETNES	S AND FROS	ST ACTION			
			GE	NERAL NO	TES			
THE ABOVE SOILS INFORMATION IS PROVIDED FROM THE NRCS WEB SOIL SURVEY AS GENERAL INFORMATION ONLY IT IS THE RESPONSIBILITY OF THE CONTRACTOR TO FIELD VERIFY ACTUAL SITE CONDITION.								
	ADDITIONAL LIMITATION NOTES							
SYMBOL	LIMITATIONS		TATIONS RESOLUTION					
CORROSIVE TO UNCOATED STEEL CONCRETE, DEPTH TO SATURATED ALL SLOPES ARE 3-8% /LESS THAN MAX. DISTURBED AREAS IN WHICH WORK CEASES FOR A PERIOD OF A DAYS SHALL BE STABILIZED. THE DRAINAGE AND APPLICABLE UTILITIES SHALL BE INSTALLED BELOW THE FROST LINE. THE DISTURBED AREAS SHALL BE STABILIZED IN A TIMELY MANNER TO LIMIT EROSION ALL UNDERGROUND CONCRETE AND STEEL FEATURES SHALL HAVE A PROTECTIVE LAYER OF LIMESTONE BETWEEN THE STRUCTURE AND THE SOIL TO PREVENT CORROSION IF REQUIRED BY THE GEOTECHNICAL POTENTIAL, WETNESS, ALL SLOPES ARE 3-8% /LESS THAN MAX. DISTURBED AREAS IN WHICH WORK CEASES FOR A PERIOD OF A DAY OF THE DRAINAGE AND APPLICABLE UTILITIES SHALL BE INSTALLED BELOW ALL UNDERGROUND CONCRETE AND STEEL FEATURES SHALL HAVE A PROTECTIVE LAYER OF LIMESTONE BETWEEN THE STRUCTURE AND THE SOIL TO PREVENT CORROSION IF REQUIRED BY THE GEOTECHNICAL POTENTIAL, WETNESS, POTENTIAL, WETNESS,								
e CON ZON TAB STRI POO FRO POT	TONE (SEASON HIGH WATER					ILLED BELOW IMIT EROSION. LIMESTONE OTECHNICAL TANDARDS ANI		

SOIL TYPES TABLE DETAIL

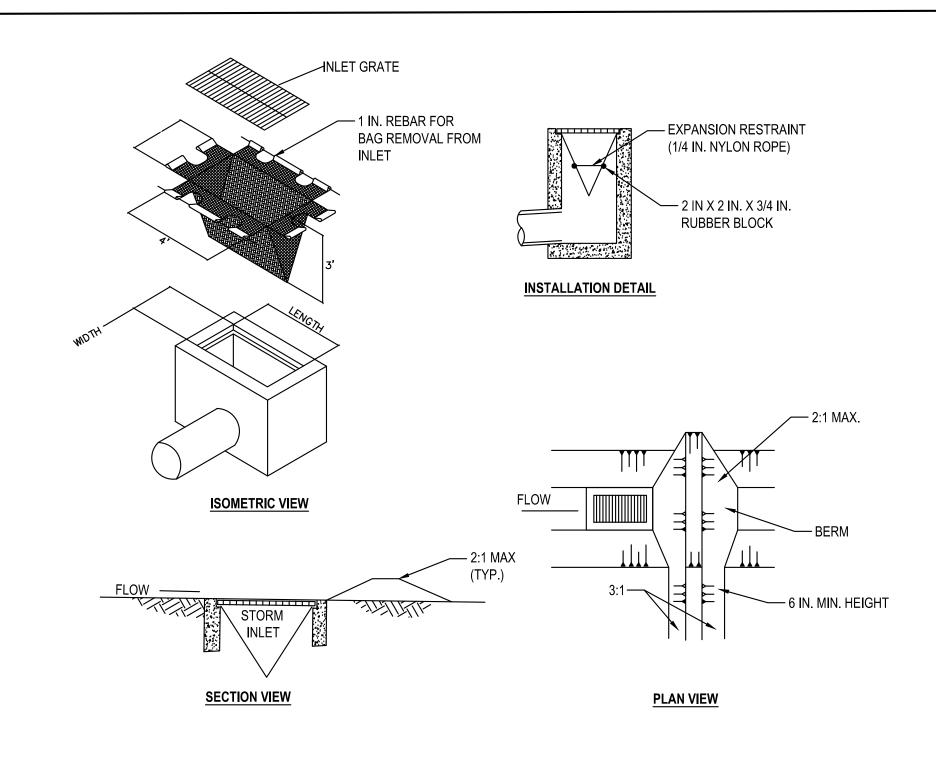



INLET FILTER BAG PROTECTION NOTES:

- 1. MAXIMUM DRAINAGE AREA = 1/2 ACRE.
- 2. INLET PROTECTION SHALL NOT BE REQUIRED FOR INLET TRIBUTARY TO SEDIMENT BASIN OR TRAP. BERMS SHALL BE REQUIRED FOR ALL

IMMEDIATELY AFTER THE INSPECTION. DISPOSE ACCUMULATED SEDIMENT AS WELL AS ALL USED BAGS ACCORDING TO THE PLAN NOTES.

- 3. ROLLED EARTHEN BERM IN ROADWAY SHALL BE MAINTAINED UNTIL ROADWAY IS STONED. ROAD SUBBASE BERM ON ROADWAY SHALL BE MAINTAINED UNTIL ROADWAY IS PAVED. EARTHEN BERM IN CHANNEL SHALL BE MAINTAINED UNTIL PERMANENT STABILIZATION IS COMPLETED OR REMAIN
- 4. AT A MINIMUM, THE FABRIC SHALL HAVE A MINIMUM GRAB TENSILE STRENGTH OF 120 LBS., A MINIMUM BURST STRENGTH OF 200 PSI, AND A MINIMUM TRAPEZOIDAL TEAR STRENGTH OF 50 LBS. FILTER BAGS SHALL BE CAPABLE OF TRAPPING ALL PARTICLES NOT PASSING A NO. 40 SIEVE.
- 5. INLET FILTER BAGS SHALL BE INSPECTED ON A WEEKLY BASIS AND AFTER EACH RUNOFF EVENT. BAGS SHALL BE EMPTIED AND RINSED OR REPLACED WHEN HALF FULL OR WHEN FLOW CAPACITY HAS BEEN REDUCED SO AS TO CAUSE FLOODING OR BYPASSING OF THE INLET. DAMAGED OR CLOGGED BAGS SHALL BE REPLACED. A SUPPLY SHALL BE MAINTAINED ON SITE FOR REPLACEMENT OF BAGS. ALL NEEDED REPAIRS SHALL BE INITIATED
- 6. DO NOT USE ON MAJOR PAVED ROADWAYS WHERE PONDING MAY CAUSE TRAFFIC HAZARDS.

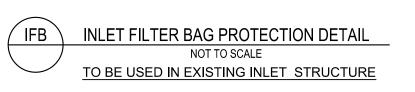

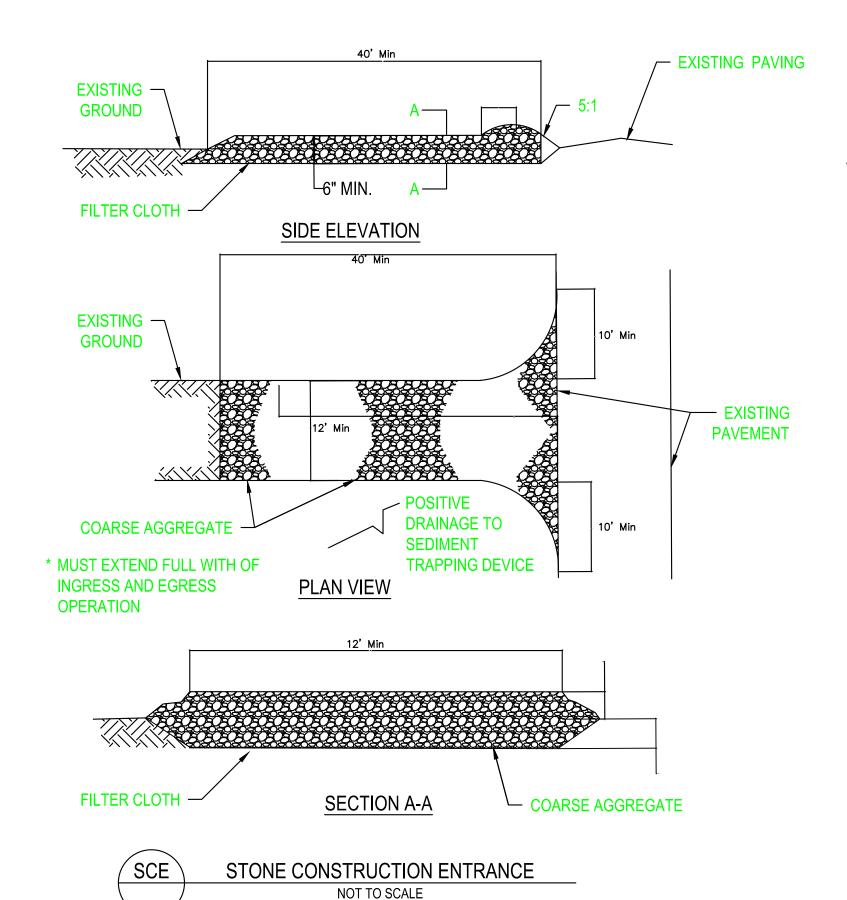

Ebensburg, PA Cambria County, PA COMPANY ADDRESS: LANDSCAPE DESIGNER PROJECT NAME:

Lake Rowena

Park

BOROUGH OF **EBENSBURG** LAKE ROWENA **DOG PARK**

CAMBRIA COUNTY

SEEDING AND MULCHING NOTES

MULCHING NOTES

- 1. STRAW SHALL BE UNROTTED, SMALL GRAIN FREE OF ALL KINDS OF WEEDS AND PROHIBITIVE NOXIOUS WEEDS SUCH AS: THISTLES, JOHNSONGRASS AND QUACKGRASS.
- 2. WOOD CELLULOSE SHALL BE GREEN DYED AND AIR-DRIED WOOD CELLULOUS FIBERS, CONTAINING NO GROWTH OR GERMINATION INHIBITING SUBSTANCES, IN PACKAGES NOT EXCEEDING ONE HUNDRED POUNDS NET WEIGHT SHOWN ON PACKAGE AND MEETING THE FOLLOWING:
- A. MOISTURE CONTENT: 14% +/- 3%
- B. ORGANIC MATTER (OVEN DRIED BASIS):98.6+/- 0.2% C. ASH CONTENT: 1.4% +/- 0.2%
- D. WATER HOLDING CAPACITY: 1000% MINIMUM
- 3. SHREDDED BARK SHALL BE SUITABLE FIBROUS GROUND, SHREDDED OR CHUNKS, AGED HARDWOOD BARK, FREE FROM VIABLE, NOXIOUS WEED SEEDS AND INSECT LIFE NOT DECOMPOSED AND BETWEEN 1/4" AND 2" IN DIMENSION
- 4. EMULSIFIED ASPHALT SHALL COMFORM TO PADOT STANDARDS CONTAINING NO SOLVENTS OR DILUTING AGENTS TOXIC TO PLANT LIFE AND NOT MORE THAN 0.75% OF SAPONIFIABLE ACIDS.
- 5. CUTBACK ASPHALT SHALL COMFORM TO PADOT STANDARDS.
- 6. NON ASPHALTIC EMULSION SHALL BE NATURAL VEGETABLE GUM BLENDED WITH JELLING AND HARDENING AGENTS (TERRA TACK AR) AS MANUFACTURED BY GRASS GROWERS COMPANY OR EQUAL.
- 7. OTHER MULCH BINDERS AS APPROVED BY THE PADEP BUREAU OF LAND AND WATER CONSERVATION.
- 8. SEEDING AND MULCHING WILL OCCUR AFTER ANY EARTH DISTURBANCE THAT WILL NOT BE DISTURBED AFTER 4 DAYS.

REV. DATE: DESCRIPTION

1-27-2022 DATE: PROJECT NO. EBG- 01 SCALE: 1"= 20' DRAWN BY: Dave Petrosky, RLA

Revised Set 1-12-23

EROSION AND SEDIMENTATION CONTROL DETAILS 2